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Plant Operations, Mel Liebmann
Collections/Safety/Maintenance, Greg Pease
Engineering, Michael P. Cortez

Administrative Services, Dale McDonald

MANAGEMENT TEAM

DISTRICT BOARD

Megan Clark

Megan Clark Ronald Ford Craig K. Murray Gary E. Robards Crystal J. Yezman

ADDENDUM NO. 1

Date: September 28, 2023

Project: Multipurpose Laboratory Building

Job No.: 24600-01

To: All Planholders and Prospective Bidders

The following changes and/or clarifications are hereby made to the Request for Proposals and shall become a part of the RFP dated August 28, 2023.

- Potholing or Subsurface Investigation No potholing information is currently available.
 Proposers shall present a project approach by assuming information shown on the as-built drawings is correct.
- 2. <u>Sea Level Rise</u> For the purpose of presenting a representative building, the selected consultant shall use finished first floor elevation of 18.0'. Proposers shall include in the approach a description of how to blend the building surroundings at existing ground elevation of 14'± in respect to ADA compliance and the future underground ultraviolet (UV) piping shown in Attachment 1 of this addendum.
- 3. Chlorine Contact Chamber (CCC) Piping For purpose of submitting a proposal, proposers shall assume the proposed building would need to encroach into the existing underground CCC piping area shown in Exhibit 2 of the RFP which would require soil stabilization and building foundation on grade beams supported by piles. Proposers are not required to present a detailed design of the building foundation; however, shall provide a brief description of the foundation and include the name of the geotechnical and structural firms in the proposal.
- 4. <u>Lab Office</u> The District has current staffing of two full-time employees for the lab department. The selected consultant shall include a design of multi-purpose office space that may serve one additional person, such as consultant.
- 5. <u>As-Built Drawings for Existing Lab Building</u> See Attachment 2 of this addendum.
- 6. Existing Lab Building District preference is to keep the existing lab building operational during construction. However, after the pre-proposal meeting, District staff evaluated proposers' concern that it may be impossible to keep the existing lab functional during construction. The selected consultant shall present a minimum of two representative buildings: 1) demolish the existing building and rent a temporary office trailer for the lab; 2) keep the existing lab during construction.
- 7. <u>Number of Employees</u> The District anticipates having a total of 31 full-time employees. The selected consultant shall design the Boardroom with enough space to accommodate all 31 employees, five Board members, and appropriate space for future growth.

- 8. <u>Availability of Biogas/Natural Gas</u> Proposers shall assume that no digester gas or natural gas will be available on site to generate heat for the proposed lab building. The selected consultant shall attempt to optimize renewable energy for all electrical and mechanical needs of the building. Proposers shall discuss the approach in the proposal.
- 9. <u>Solar Power System</u> Proposers shall include installation of off-grid standalone solar panels for power generation at the new lab building, such as rooftop installation, in the proposal. The District is in the process of upgrading its solar photovoltaic system in the Reclamation Area to generate power for the treatment facilities unrelated to the new lab building.
- 10. <u>Electric Vehicle (EV) Parking</u> The selected consultant shall consult the appropriate planning and building department guidelines for the number of EV or clean energy charging stations required in the proposed parking lot.
- 11. <u>Lab Design Project References</u> Proposers shall include experience on laboratory design projects for wastewater or water treatment facilities in the reference section of the proposal. The District may not review or consider unrelated references, such as medical or electronics laboratory.
- 12. <u>Geotechnical Reports</u> See Exhibit 3 of the RFP for geotechnical reports. No additional reports are available.
- 13. <u>Hazardous Materials</u> The selected consultant shall be prepared to develop proper hazardous materials disposal guidelines and include a survey for the existing lab building to identify asbestos, lead, and other hazardous materials.
- 14. <u>Project Schedule</u> Assuming the project would require City planning approval and building permit, the selected consultant shall simultaneously design and apply for the necessary permits during the 9-month design phase. The District may consider extending the design duration for a more feasible schedule pending permit application timeline, if necessary.
- 15. <u>Value Engineering</u> Proposers shall not include an allowance for value engineering in the proposal. However, the District may elect to add value engineering in the design scope as a contract amendment if deemed necessary for grant application and other purposes.
- 16. <u>Proposal Page Limit</u> The page limit for the proposal is 15 pages, including resumes and project references. Fee schedule may be on a separate 11" x 17" sheet. Cover page, cover letter, and fee schedule are exempt from the maximum 15-page limit.
- 17. <u>Planning and Building Permits</u> According to Government Code §53091(d), building ordinances of a county or city shall not apply to the location or construction of facilities for the production, generation, storage, treatment, or transmission of water, wastewater, or electrical energy by a local agency. In addition, LGVSD is zoned Public/Quasi-Public District (P/QP). The selected consultant shall discuss anticipated planning and building permit requirements for the proposed lab building as it relates to the Government Code §53091(d) and pertinent City ordinance sections.

Questions Received from Proposers:

The following questions were submitted before 9/28/2023. Questions that are received after the RFP question deadline may not be answered in an addendum. LGVSD responses to the questions are in bold.

- Q1. 6.0 Proposal Requirements and Contents has conflicting information on the page limit. Is the page limit 10 or 15 pages? Are resumes included in the page limit? If so, are you expecting full resumes for the Prime Consultant team and resumes for all Sub Consultants?
 - Response: See Item No. 16 above. Proposers shall include resumes highlighting relevant projects for key members of the project team.
- Q2. Scope item E describes Bidding Phase Services only. Please clarify Construction Phase services vs. Construction Management and Inspection Services listed in section F. Do you require a full-time on-site construction manager that acts on behalf of the District? Response: Construction Phase Services are related to technical questions that would need to be addressed by the design architect during construction, such as providing responses to RFI's and submittals. Construction Management and Inspection Services refer to a full-time on-site construction manager and/or inspector acting on behalf of the District to interact with the contractor during construction, including but not limited to inspections, conducting progress meetings, and document control.
- Q3. Seeing that questions aren't due until the 28th and the proposal is due on the 5th, would you consider answering questions before the 28th or extending the due date out a week? Response: The proposal deadline will not be extended unless otherwise noted via another addendum.
- Q4. 'Maximum Number of Pages: 15 single-sided pages including resumes and list of sample projects. Fee schedule may be on a separate 11" x 17" sheet. Cover page, cover letter, and fee schedule are exempt from the maximum 10-page limit'. Please confirm the maximum number of pages, 10 or 15?
 - Response: See Item No. 16 above.
- Q5. Are Hourly Rates required for the prime and for the subconsultants?

 Response: Yes, the information can be included on the separate 11" x 17" fee schedule.
- Q6. Is it possible to change the 15-page limit to exclude the Key Personnel resumes? Or include resumes in an appendix section that does not count to the 15-page limit? **Response: See Item No. 16 above.**
- Q7. Will you be sending out a mass answer to all asked questions after the 9/28 deadline? Will you be sending our periodic answers?

Response: The District anticipates this addendum should provide clarifications to all questions received during the pre-proposal meeting and before 9/28. Questions received on 9/28 will be answered in the future addendum.

Q8. Who is the Authority Having Jurisdiction (A.H.J.) over this project? City of San Rafael?

Response: See Item No. 17 above.

Q9. Who will be the CEQA Lead Agency for this project? **Response:** Las Gallinas Valley Sanitary District.

Q10. Should preparation of full CEQA documents, and required investigations and community outreach be included in scope and fee?

Response: Yes, it will be the selected consultant's responsibility to conduct

Response: Yes, it will be the selected consultant's responsibility to conduct environmental reviews pursuant to CEQA and prepare all necessary CEQA documents.

- Q11. Will a detailed program for the building and different departments be provided or should the design team include programming services in scope and fee?

 Response: The design team selected shall include programming services only for the new building. Note that only lab staff will be working in the proposed lab building and that other department staff will have or already have their designated workstations elsewhere.
- Q12. Will new laboratory program be based on existing laboratory?

 Response: Most features of the existing laboratory may not be up to current standards. Design the program to allow flexibility and future expandability.
- Q13. Will drawings of the existing laboratory building be provided? **Response: See Item No. 5 above.**
- Q14. Will a complete equipment list be provided?

Response: See RFP for a list of existing equipment that needs to be accommodated in the new lab building. Proposers shall use their best judgement on additional equipment based on prior experience in designing lab buildings for wastewater or water treatment facilities, and are welcome to visit the existing lab to gather additional information as necessary.

Q15. Will a Hazmat list and MSDS sheets be provided? Will LGVSD be working with a Hazmat consultant directly or should the design team include a consultant for these services?

Response: Available Hazmat list and MSDS sheets will be provided to the selected consultant after contract award. Proposers shall include in the proposal an allowance for a Hazmat subconsultant in the design team.

Q16. How many full-time employees (Lab + Office + Education Center) should be accounted for in the new building?

Response: See Item No. 7 above. There are currently two full-time employees at the existing lab building. The education center is for visitors. It is anticipated that no full-time employees will be permanently working in the education center.

- Q17. How many people should the Classroom / Board Room be able to accommodate?

 Response: The dual-purpose classroom and Boardroom shall be able to accommodate the 31 full-time employees, 5 Board members, and additional space for visitors and consultants.
- Q18. The RFP doesn't mention an office program, but there are offices in the existing laboratory building. Will offices be required in the new building? If yes, what is the expected program (number of employees, open vs private offices, conference spaces, amenities, etc.)?

Response: See applicable responses above. The selected consultant has the option to include open or private offices, conference spaces, amenities, etc. in the design; however, shall provide sufficient justifications, advantages, and disadvantages for further review by the District.

- Q19. What are the required deliverables for the 3 conceptual design schemes (ie: interior and exterior plans, finishes, interior and exterior renderings)?

 Response: Each design scheme shall at a minimum include plans, finishes, and renderings for the exterior, and any additional information that may be necessary for the District to make an informative decision. The selected consultant shall develop interior plans, finishes, and renderings for the selected design scheme and shall be prepared to make modifications per District comments.
- Q20. What is the required scale for the physical model?

 Response: The District has no preference of the scale of the physical model. The selected consultant has the prerogative to select an appropriate scale that would allow the District to visualize the spatial relationship between the new building and its surroundings.
- Q21. Has a sea level rise study been done?

 Response: No. The District is in the plannin

Response: No. The District is in the planning phase of developing an in-depth sea level rise mitigation study to identify the areas of vulnerability. However, proposers shall assume a finished floor elevation of 18.0' for the building in the proposal.

Q22. What is the status of entitlement and permitting?

Response: None has been initiated by the Distr

Response: None has been initiated by the District for this project. Proposers shall investigate and determine appropriate entitlement and permitting requirements for the building and provide a summary of their understanding of applicable codes or City ordinance in the proposal.

- Q23. Any preliminary application has been filled with utility providers?

 Response: None has been initiated by the District for this project. The selected consultant shall include utility applications such as PG&E, cable, telephone, water, etc. in the design phase.
- Q24. Will we be expected to provide a Topographic Survey or will one be provided? Response: The selected consultant shall include an allowance for topographic surveys in the proposal.
- Q25. Does the district have record topo of the site that can be shared now? **Response: See response to Q24.**
- Q26. Is it possible to get a copy now of the geotechnical work done to date by Miller Pacific? **Response: See Item No. 12 above.**
- Q27. Has the district had success in the past getting grant and foundation funding? From what sources?

Response: The District received two grants from the California Energy Commission for biogas energy recovery system and renewable natural gas fueling stations. Also, the District received WaterSMART grant(s) from the USBR for the construction and expansion of the LGVSD Recycled Water Facility.

- Q28. Do you have a plot of the PG&E easement that constrains the building design?

 Response: See Attachment 3 of this addendum for legal descriptions and plats of the PG&E easement.
- Q29. May we have a copy of the Sea Level Rise and Storm Surge study that determined the EL 18.0?

Response: See response to Q21.

- Q30. For the Education Center, is the expectation for the architect to deliver a finished interior space for that second floor area that can feature 'future' interactive exhibits? OR is exhibit design for this area a part of the scope of services? If so, what are the expectations for the interactive exhibit design scope?
 - Response: It is anticipated that the selected consultant shall prepare a final interactive exhibit design to be incorporated into the bidding documents for construction as part of the project.
- Q31. Does the exhibit design scope of work include educational content creation and conceptual approach in collaboration with LGVSD? Or does LGVSD have an outline of intended learning outcomes, approximate content and criteria for exhibits to support those outcomes to be issued to the firm?
 - Response: The exhibit design scope of work shall include educational content creation and conceptual approach in collaboration with LGVSD. The District does not have an outline for intended learning outcomes, content and criteria for the exhibits.

- Q32. What is the targeted age range for the education center audience/users?

 Response: No specific age range. The intent of the education center is to educate the public.
- Q33. For exhibit design scope, how many exhibits do you envision? Four (4)? One (1) for each initiative: 1.wastewater collection & treatment processes, 2. recycled water production, 3. water conservation, 4.proper item disposal?

 Response: The selected consultant shall use their best judgement to determine the number of exhibits based on proposed available space. It is the intent for the District to include at least one exhibit for: wastewater collection, wastewater treatment, recycled water production, and other items as outlined in the RFP.
- Q34. The reference link provided for the interactive space includes physical object interaction paired with digital info/response do you expect each exhibit to be physical digital exhibits?

Response: Proposers shall include in the proposal an allowance to develop both options for District review.


Q35. If exhibits include digital experiences/interactivity, what is the scope expectation for the specification of digital hardware and software?

Response: See response to Q34.


- Q36. If exhibits include digital experience/interactivity, does the scope include creation and development of the digital experience/content? If yes, do you have information at this time to help quantify the digital content creation and development scope/budget? Or should an allowance be noted for further definition once scope is quantified? **Response: See response to Q34.**
- Q37. What portion of the overall construction budget is allocated for the education center? Response: The construction budget provided in the RFP is a preliminary number for the entire building and ancillary components. A budget allocation with percentage for each major component is not currently available. The selected consultant shall be responsible for preparing cost estimates based on the final design selected by the District.

This addendum consists of forty-nine (49) pages including this page and attachments. Acknowledge receipt of this addendum by signing in the space provided below. Submit an original copy of this addendum cover page along with the proposal.

Las Gallinas Valley Sanitary District:	Proposer:	
Michaelpon		
Michael P. Cortez, PE, District Engineer	(Authorized Signature)	(Date)

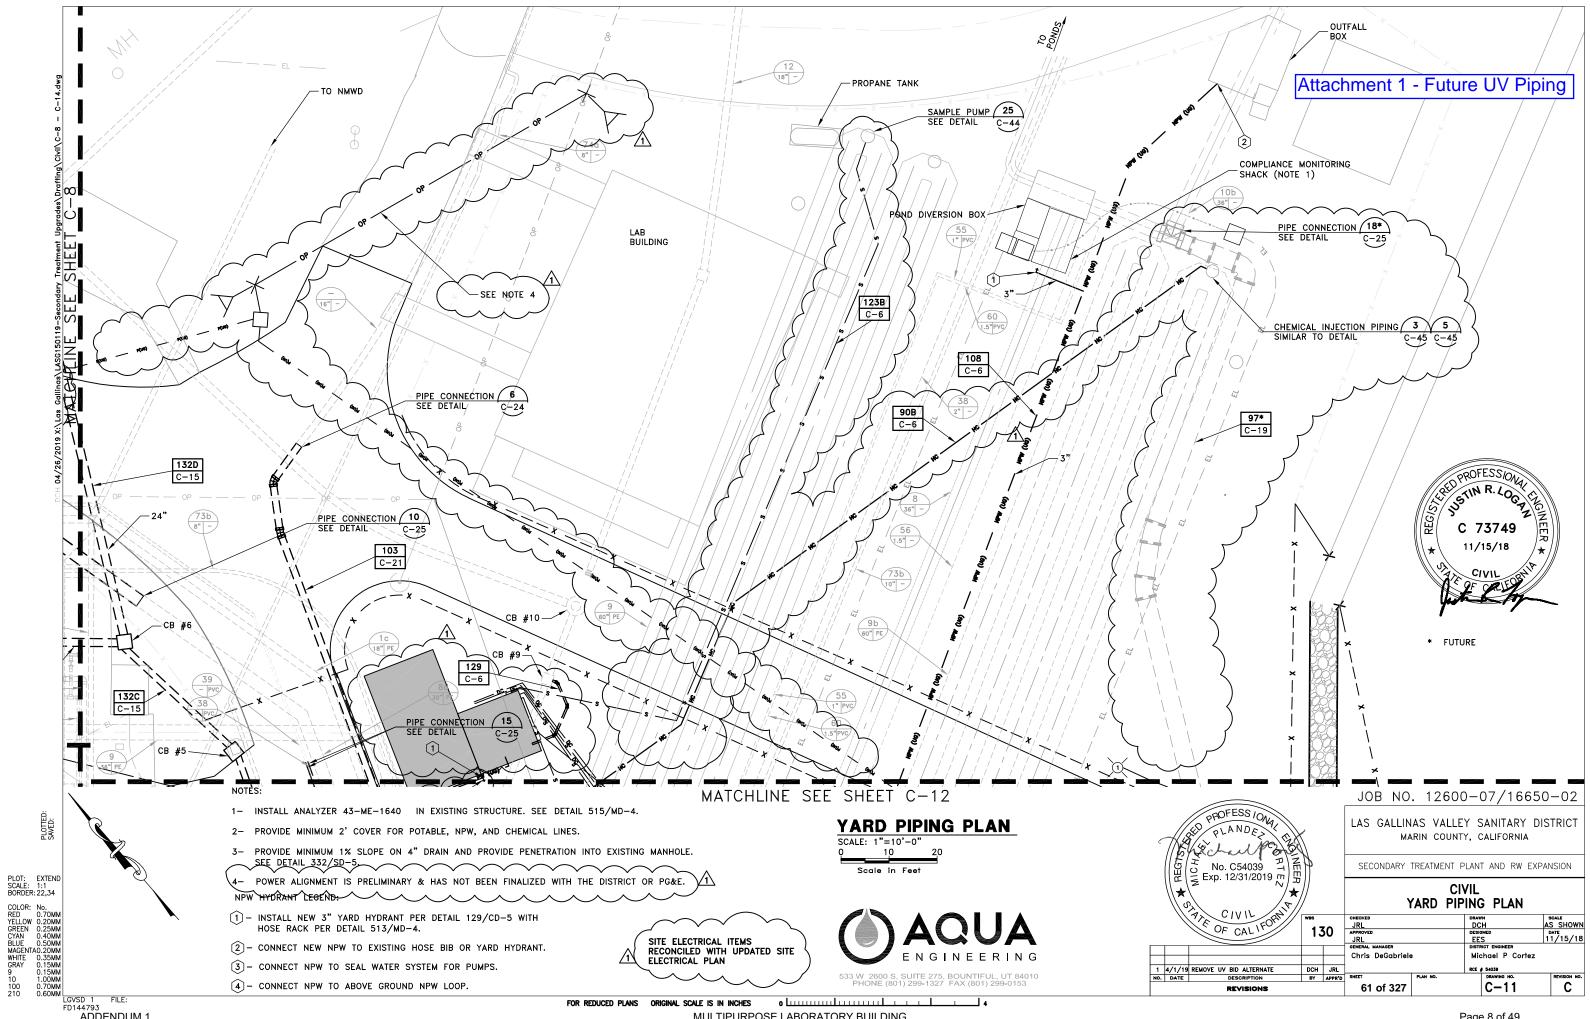

ADDENDUM 1

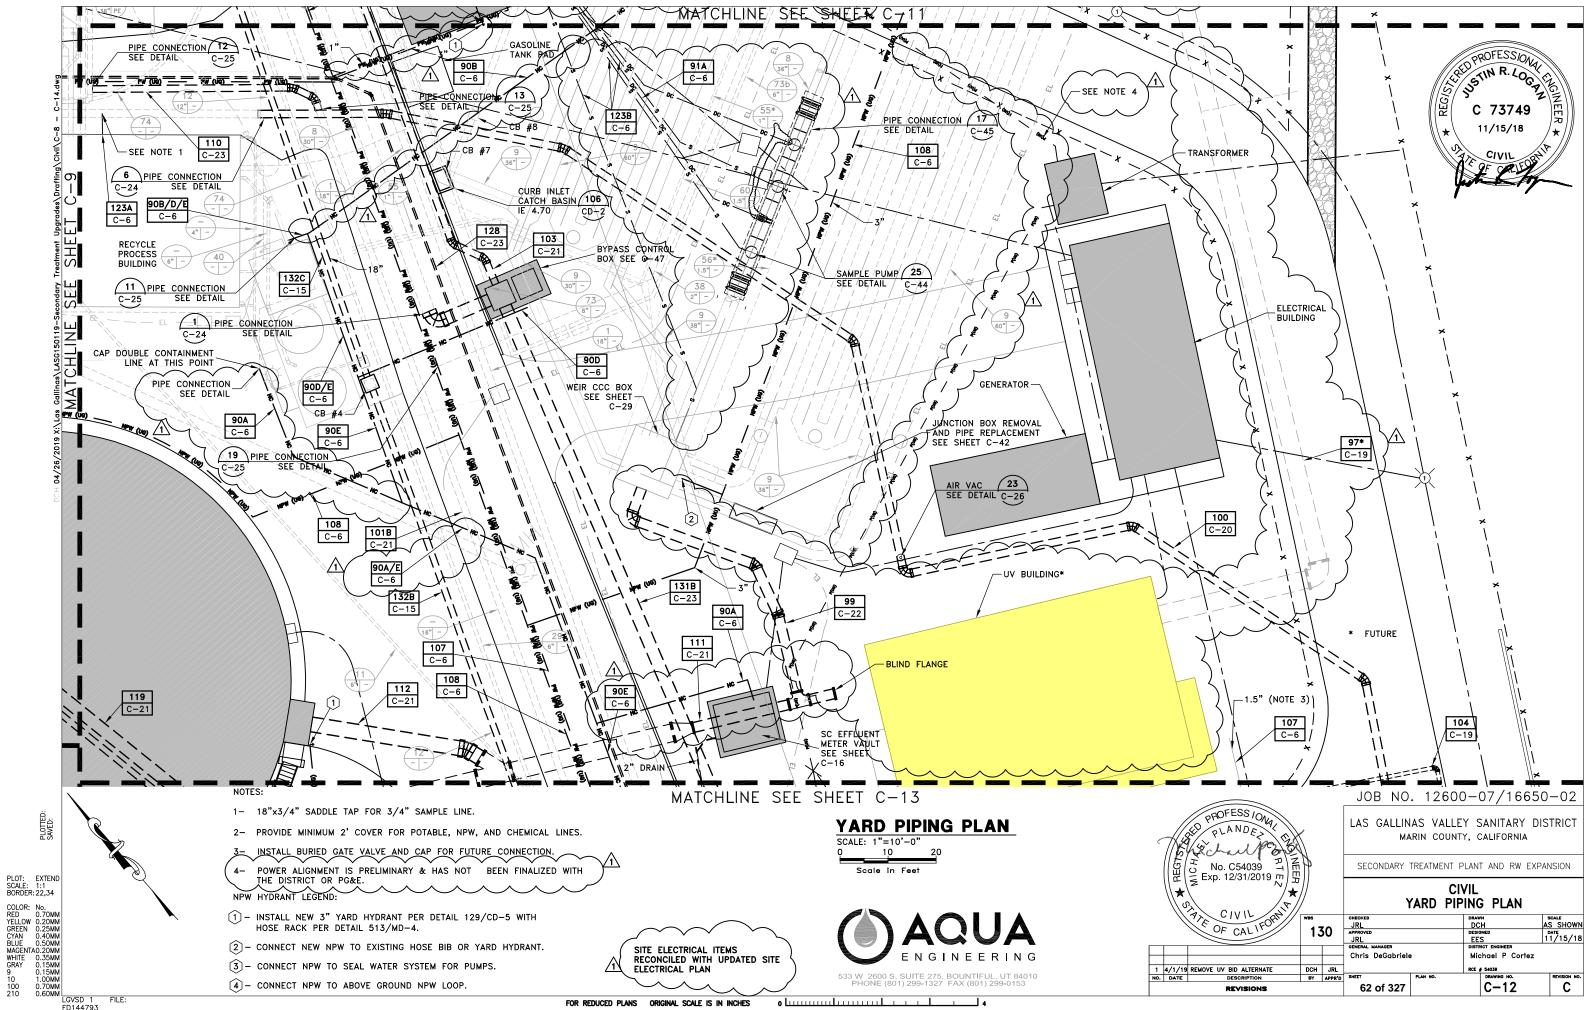


ADDENDUM 1

IAS TAINAS SANITARY DISTRICT

-San Rafael, California-

Attachment 2 - 2000 Lab Building As-Built

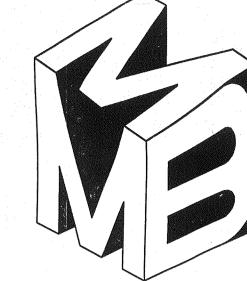

MEEHLEIS MODULAR BUILDINGS, INC. A DESIGN BUILD COMPANY

1303 E. LODI AVE. LODI, CA. 95240 (209) 334-4637 CA. LIC. NO. 473488 NV. LIC. NO. 37887

JULY 24, 2000

Las

DRAWN: KMC

CHECKED:

REVISIONS:

SYMBOLS

A	WINDOW TYPE ON FLOOR PLAN & SCHEDULE
1	CASEWORK TYPE ON FLOOR PLAN & SCHEDULE
$\sqrt{5}$	DOOR TYPE ON FLOOR PLAN & SCHEDULE
\bigwedge	REFERS TO NOTE NO. 3

<u>-</u>	REFERS TO DETAIL ON SHEET A-4	NO.4

MODULE NO.

NOTES:

LOCATION: LAS GALLINAS VALLEY SANITARY DISTRICT 300 SMITH RANCH ROAD SAN RAFAEL, CA 94903

DESIGN LOADS:

75 M.P.H. EXPOSURE "C" SEISMIC: ZONE 4 Z=0.4 RW=6 90 P.S.F. LIVE LOAD V-N CONSTRUCTION B OCCUPANCY

OCCUPANT LOAD:

APPLICABLE CODES:

CONSTRUCTION SHALL COMPLY WITH THE FOLLOWING: 1997 UBC 1996 NEC 1997 UMC 1997 UPC 1997 UFC

F.A. F.A.P. F.D.

FIRE ALARM

FLOOR ACCESS PANEL FLOOR DRAIN

ABBREVIATIONS

A.B. A/C A.D. A.S.T.M. ACOUST. ADD. ALT. ALUM. ARCH. AUTO.	AGGREGATE BASE OR ANCHOR BOLT ASPHALTIC CONCRETE AREA DRAIN AMERICAN SOCIETY FOR TESTING AND MATERIALS ACOUSTICAL ADDITIONAL ALTERNATE ALUMINUM ARCHITECTURAL AUTOMATIC	F.E. F.F. F.G. F.N. F.O.C. F.O.S. FIN. FOUND. FT. FTG.	FIRE EXTINGUISHER FINISH FLOOR FINISH GRADE FLAT HEAD FIELD NAILING FACE OF BLOCK FACE OF CURBE OR CONCRTE FACE OF STUD FINISH FLOOR FOUNDATION FEET FOOTING	MTD. MTL. N. N.I.C. N.T.S. NO.	MOUNTED METAL NORTH NOT IN CONTACT NOT TO SCALE NUMBER	T&B T&G T.O.B. T.O.C. T.O.S. T.P.D. TEL. THRESH. TYP.
BD. BLD'G. BLK. BLK'G. BM. BOT.	BOARD BUILDING BLOCK BLOCKING BEAM BOTTOM	G.I. GA. GALV. GR. GYP.	GALVANIZED IRON GAUGE GALVANIZED GRADE GYPSUM	0/ 0.C. 0.D. 0.H. 0BS. 0PEN. 0PP.	OVER ON CENTER OUTSIDE DIMENSION OR DIAMETER OVER HANG OBSCURE OPENING OPPOSITE	U.B.C. U.L. U.O.N. V.C.T. VERT.
C.B.C.C.C.E.F.C.L.J.L.C.C.P.B.C.P.C.B.C.C.B.C.C.C.C.C.C.C.C.C	CALIFORNIA BUILDING CODE CATCH BASIN CALIFORNIA CODE OF REGULATIONS CEILING EXHAUST FAN CAST IRON CONSTRUCTION LOINT CHAIN LINK CLEAN OUT TO GRADE COMPLETE PENETRATION CABINET CERAMIC CHALK BOARD CEILING COLUMN	H.B. H.C. H.D. HD. WD. HORIZ. HR. HT.	HOSE BIB HOLLOW CORE HOT DIPPED HARD WOOD HORIZONTAL HOUR HEIGHT	P.L. P. LAM. P.P. P.S.F. P.S.I. P.T.D.F. PERF. PL. PLYWD. PORT. PR. PRE-FAB.	PROPERTY LINE PLASTIC LAMINATED PARTIAL PENETRATION POUNDS PER SQUARE FOOT POUNDS PER SQUARE INCH PRESSURE TREATED DOUGLAS FUR PERFORATED PLATE PLYWOOD PORTABLE PAIR PRE FABRICATED	W. W/O W.C. W.H. W.S. WD. WSCT.
CONC. CONT. D.F. D.I.	CONCRETE CONTINOUS DRINKING FOUNTAIN OR DOUGLAS FUR DRAIN INLET	I.C.B.O. I.D. IN. INFO. INSUL. INT.	INTERNATIONAL CONFERENCE OF BUILDING OFFICIALS INSIDE DIMENSION OR DIAMETER INCH INFORMATION INSULATION INTERIOR	R.A.G. R.B. R.D.	RETURN AIR GRILL RUBBER BASE ROOF DRAIN	
D.S. DBL. DET. DIA. DIM. DN. DR. DRW ^I G.	DOWN SPOUT DOUBLE DETAIL DIAMETER DIMENSION DOWN DOOR DRAWING	JAN, JST.	JANITOR JOIST	R.O. R.W.L. REINF. REQ'D RET. RM. RWD.	ROUGH OPENING REINFORCING REQUIRED RETURN ROOM REDWOOD	
		K.D.	KNOCK DOWN			
E. E.J. E.N. E.S. E.W. EA. ELEV. ELECT. EQ. EQUIP. EXIST. EXP. EXT. EXT.	EAST EXPANSION JOINT EDGE NAILING EACH SIDE EACH WAY EACH ELEVATION ELECTRICAL EQUAL EQUIPMENT EXISTING EXPANSION EXTERIOR EXTINGUISHER	L.B. LAV. LB. LT. WT.	LAG BOLT LAVATORY POUND LIGHT WEIGHT	S. A.D. S. A.C. D. S. N. S. N. S. N. S. N. S. N. S.	SOUTH SUPPLY AIR DIFFUSER SOLID CORE SEAT COVER DISPENSER STORM DRAIN OR SOAP DISPENSER SHEET METAL SHEET METAL SCREW SANITARY NAPKIN DISPENSER SANITARY NAPKIN RECEPTICAL SCHEDULE SERVICE SHEET SIMILAR SLIDING SPECIFICATION SQUARE	
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MAX.

MECH.

MEMB.

MFR. MIN. MISC.

MAXIMUM

MINIMUM

MECHANICAL

MEMBRANE.

MANUFACTURER

MISCELLANEOUS

DESCRIPTION

0	COVER SHEET & PROJECT INFO
C-1	SITE PLAN
A-1	FLOOR PLAN
A-2	REFLECTED CEILING PLAN
A-2A	CEILING DETAILS
A-3	ARCHITECTURAL CROSS - SECTION
A-4	ARCHITECTURAL DETAILS
A-5	EXTERIOR ELEVATIONS
A-6	INT. FINISH SCHEDULE, DOOR SCHEDULE, & DETAILS
SF-01	SOIL, FOUNDATION AND CONCRETE NOTES & DETAILS
SF-I	FOUNDATION PLAN & DETAILS
SF-2	FOUNDATION DETAILS
5-1	
5-1 5-1A	FLOOR FRAMING PLAN W/ MEMBER SCHEDULE
5-1A 5-2	ROOF FRAMING PLAN W/ MEMBER SCHEDULE
5-2 5-2A	STRUCTURAL DETAILS AT ROOF
	STRUCTURAL DETAILS AT FLOOR
5-3	STRUCTURAL CROSS-SECTION W/ TYP. WALL FRMG. E
S-3A	STRUCTURAL NOTES W/ TYP. WALL ANCHOR DETAILS
M-1	MECHANICAL PLAN W/ DETAILS
M-2	MECHANICAL DETAILS
	The state of the s
P-I	PLUMBING PLAN
E-I	POWER PLAN & PANEL SCHEDULE

VICINITY MAP

LIGHTING LAYOUT

E-2

SHEETS

STRUCTURAL ENGINEER

SHEET NO.

MULTIPURPOSE LABORATORY BUILDING

Stub coldwarden t

wisto lucto

outede contor of

South most to 220 Dishwich Art FP1

TOP AND BOTTOM TONGUE AND GROOVE

TELEPHONE THRESHOLD TYPICAL

TOP OF BLOCK TOP OF CURB OR CONCRETE

TOP OF SLAB TOILET PAPER DISPENSER

UNIFORM BUILDING CODE UNDERWRITERS LABORATORY UNLESS OTHERWISE NOTED

VINYL COMPOSITION TILE

VERTICAL

WEST WITH WITH OUT

WAINSCOAT

WATER CLOSET WATER HEATER WATER PROOF WOOD SCREWS


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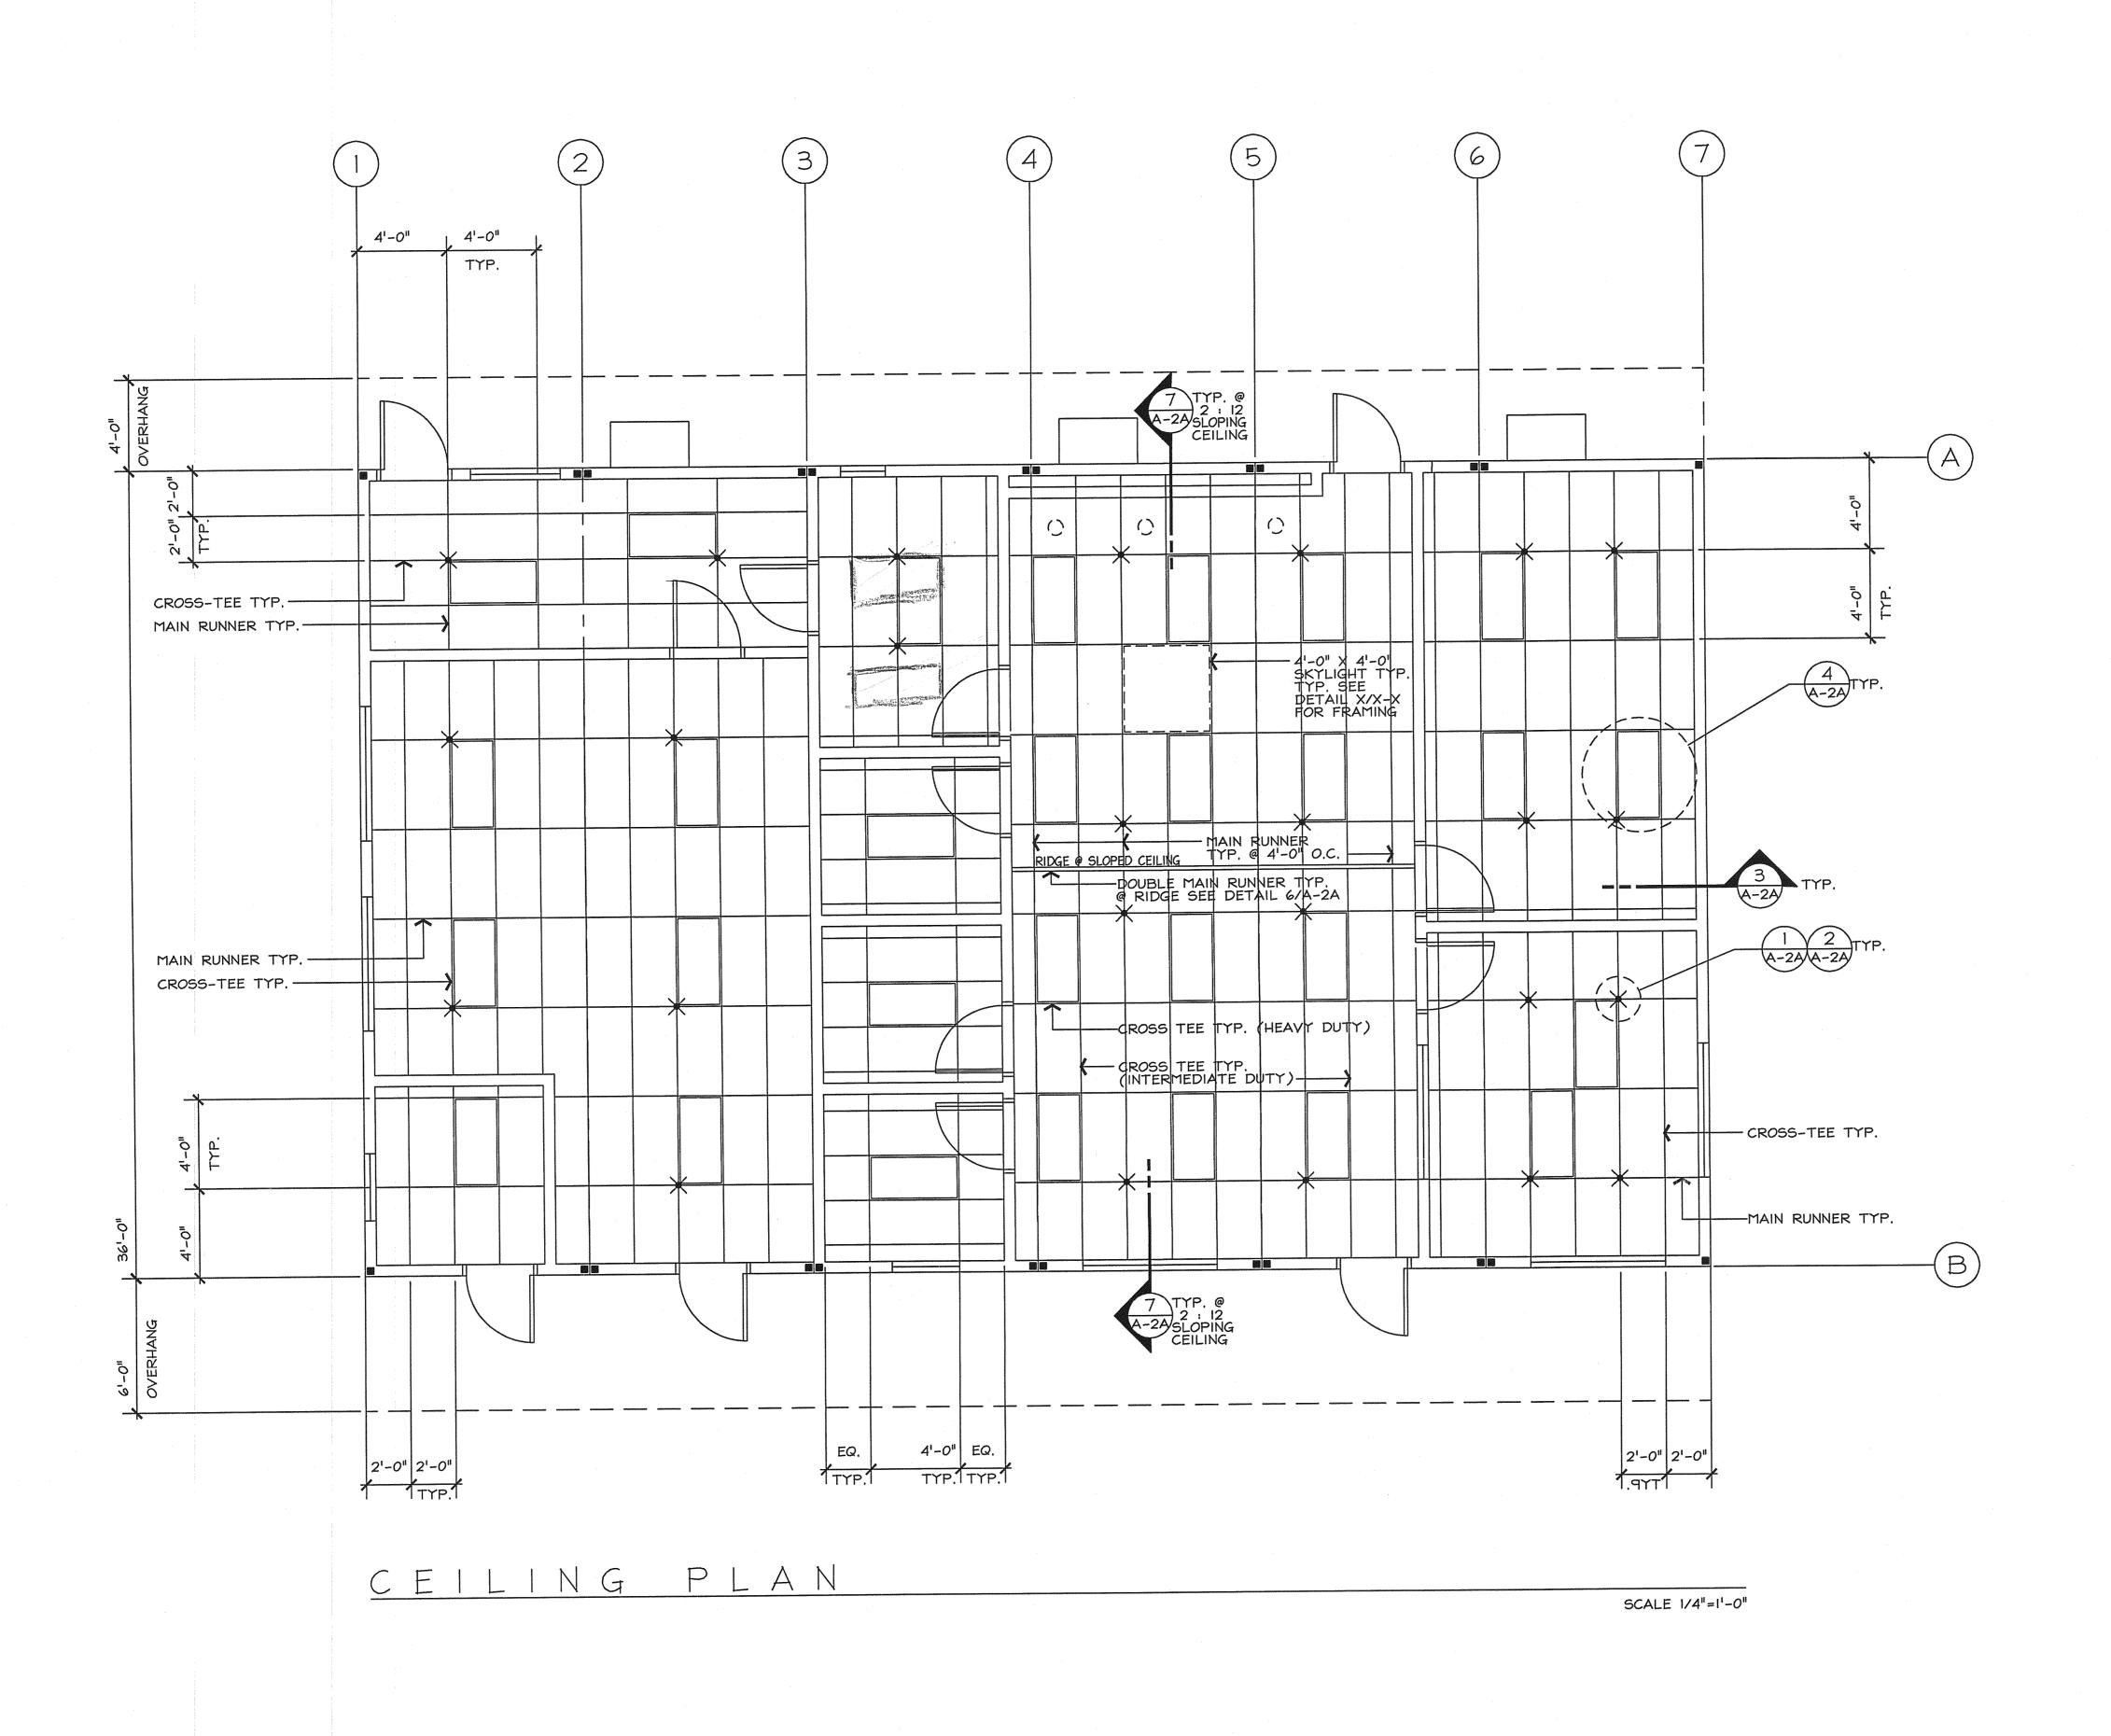
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FLOOR PLAN

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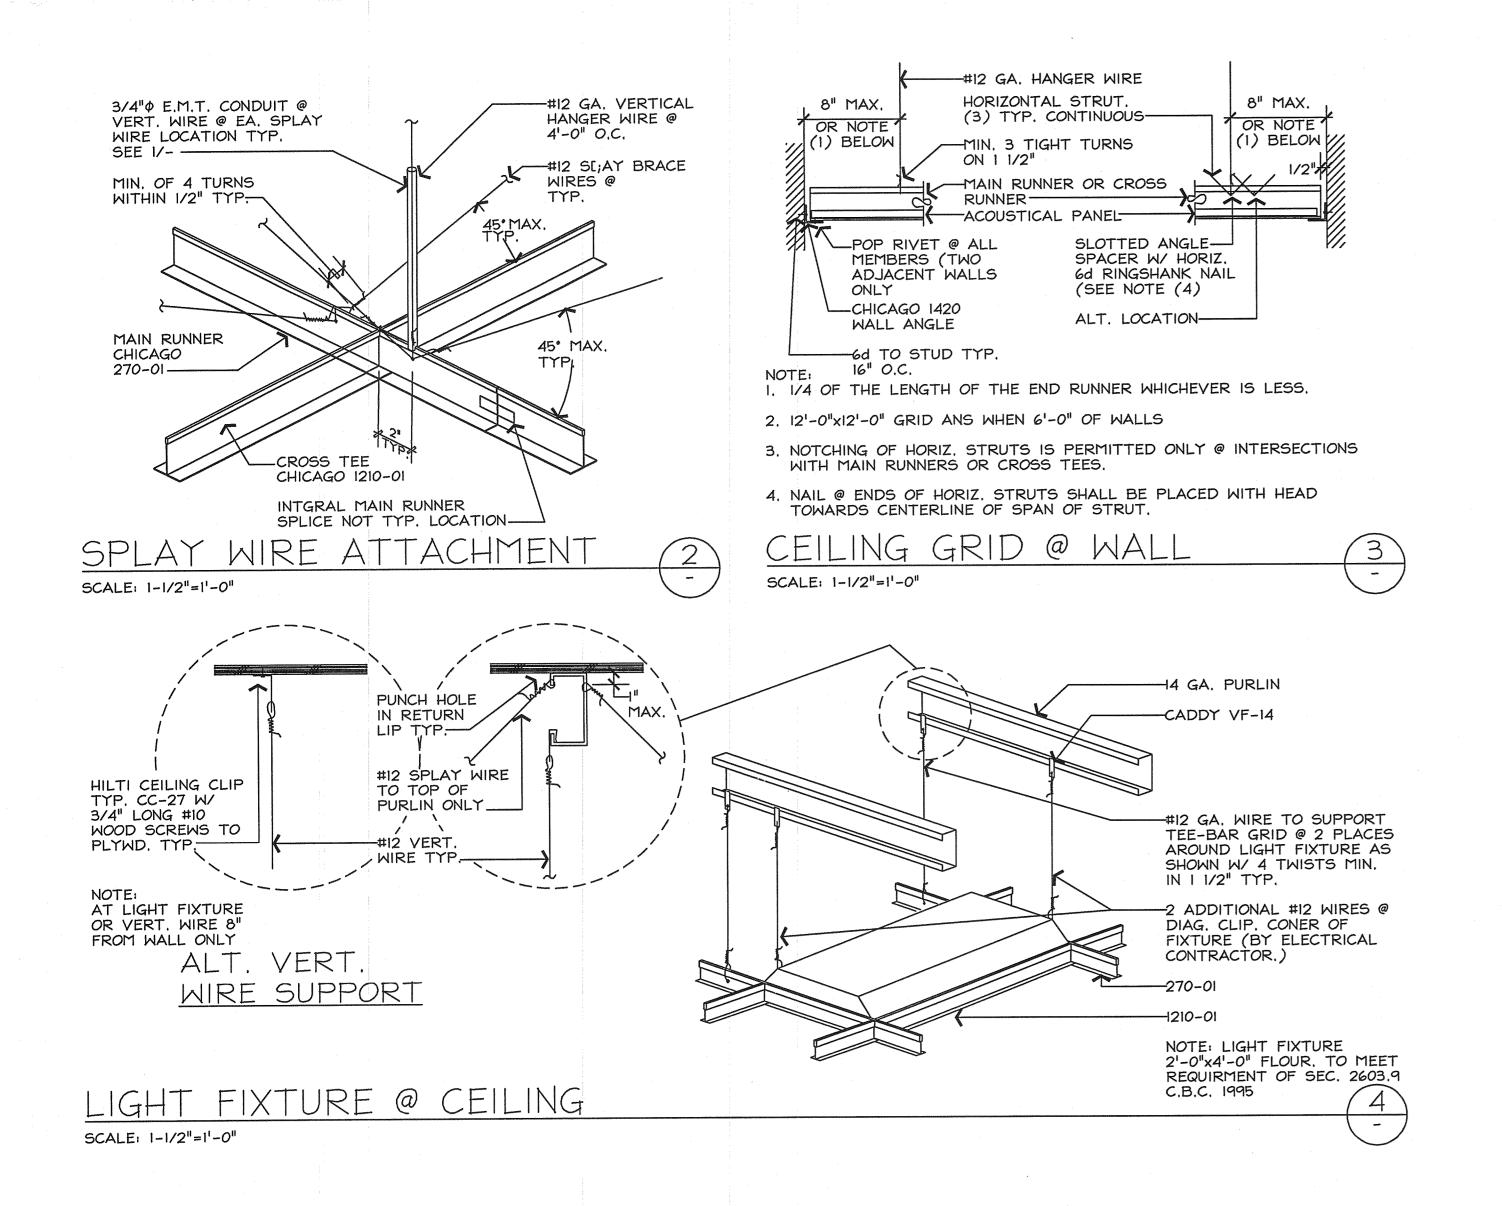
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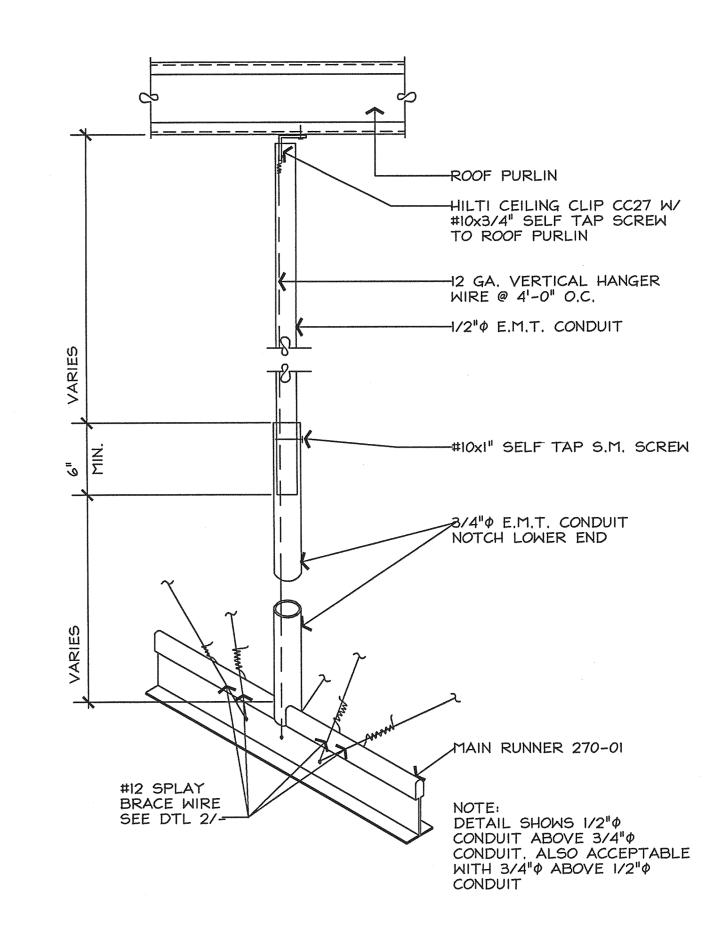





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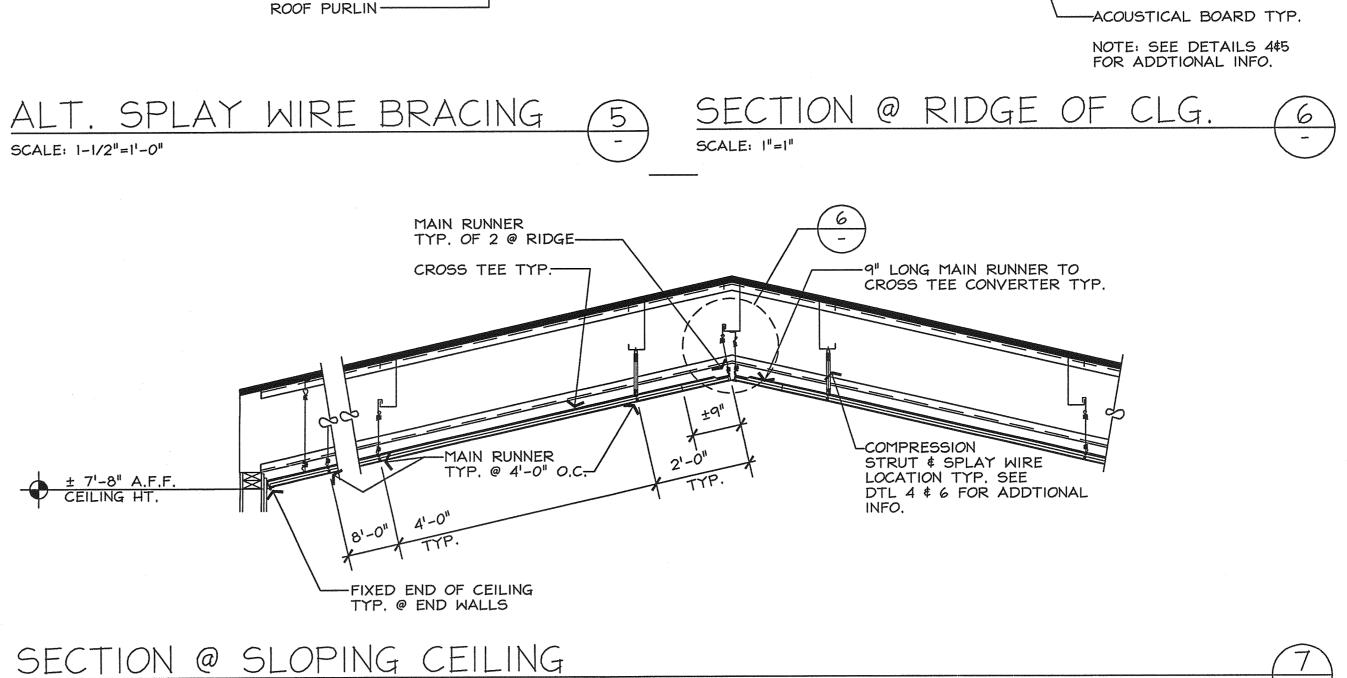


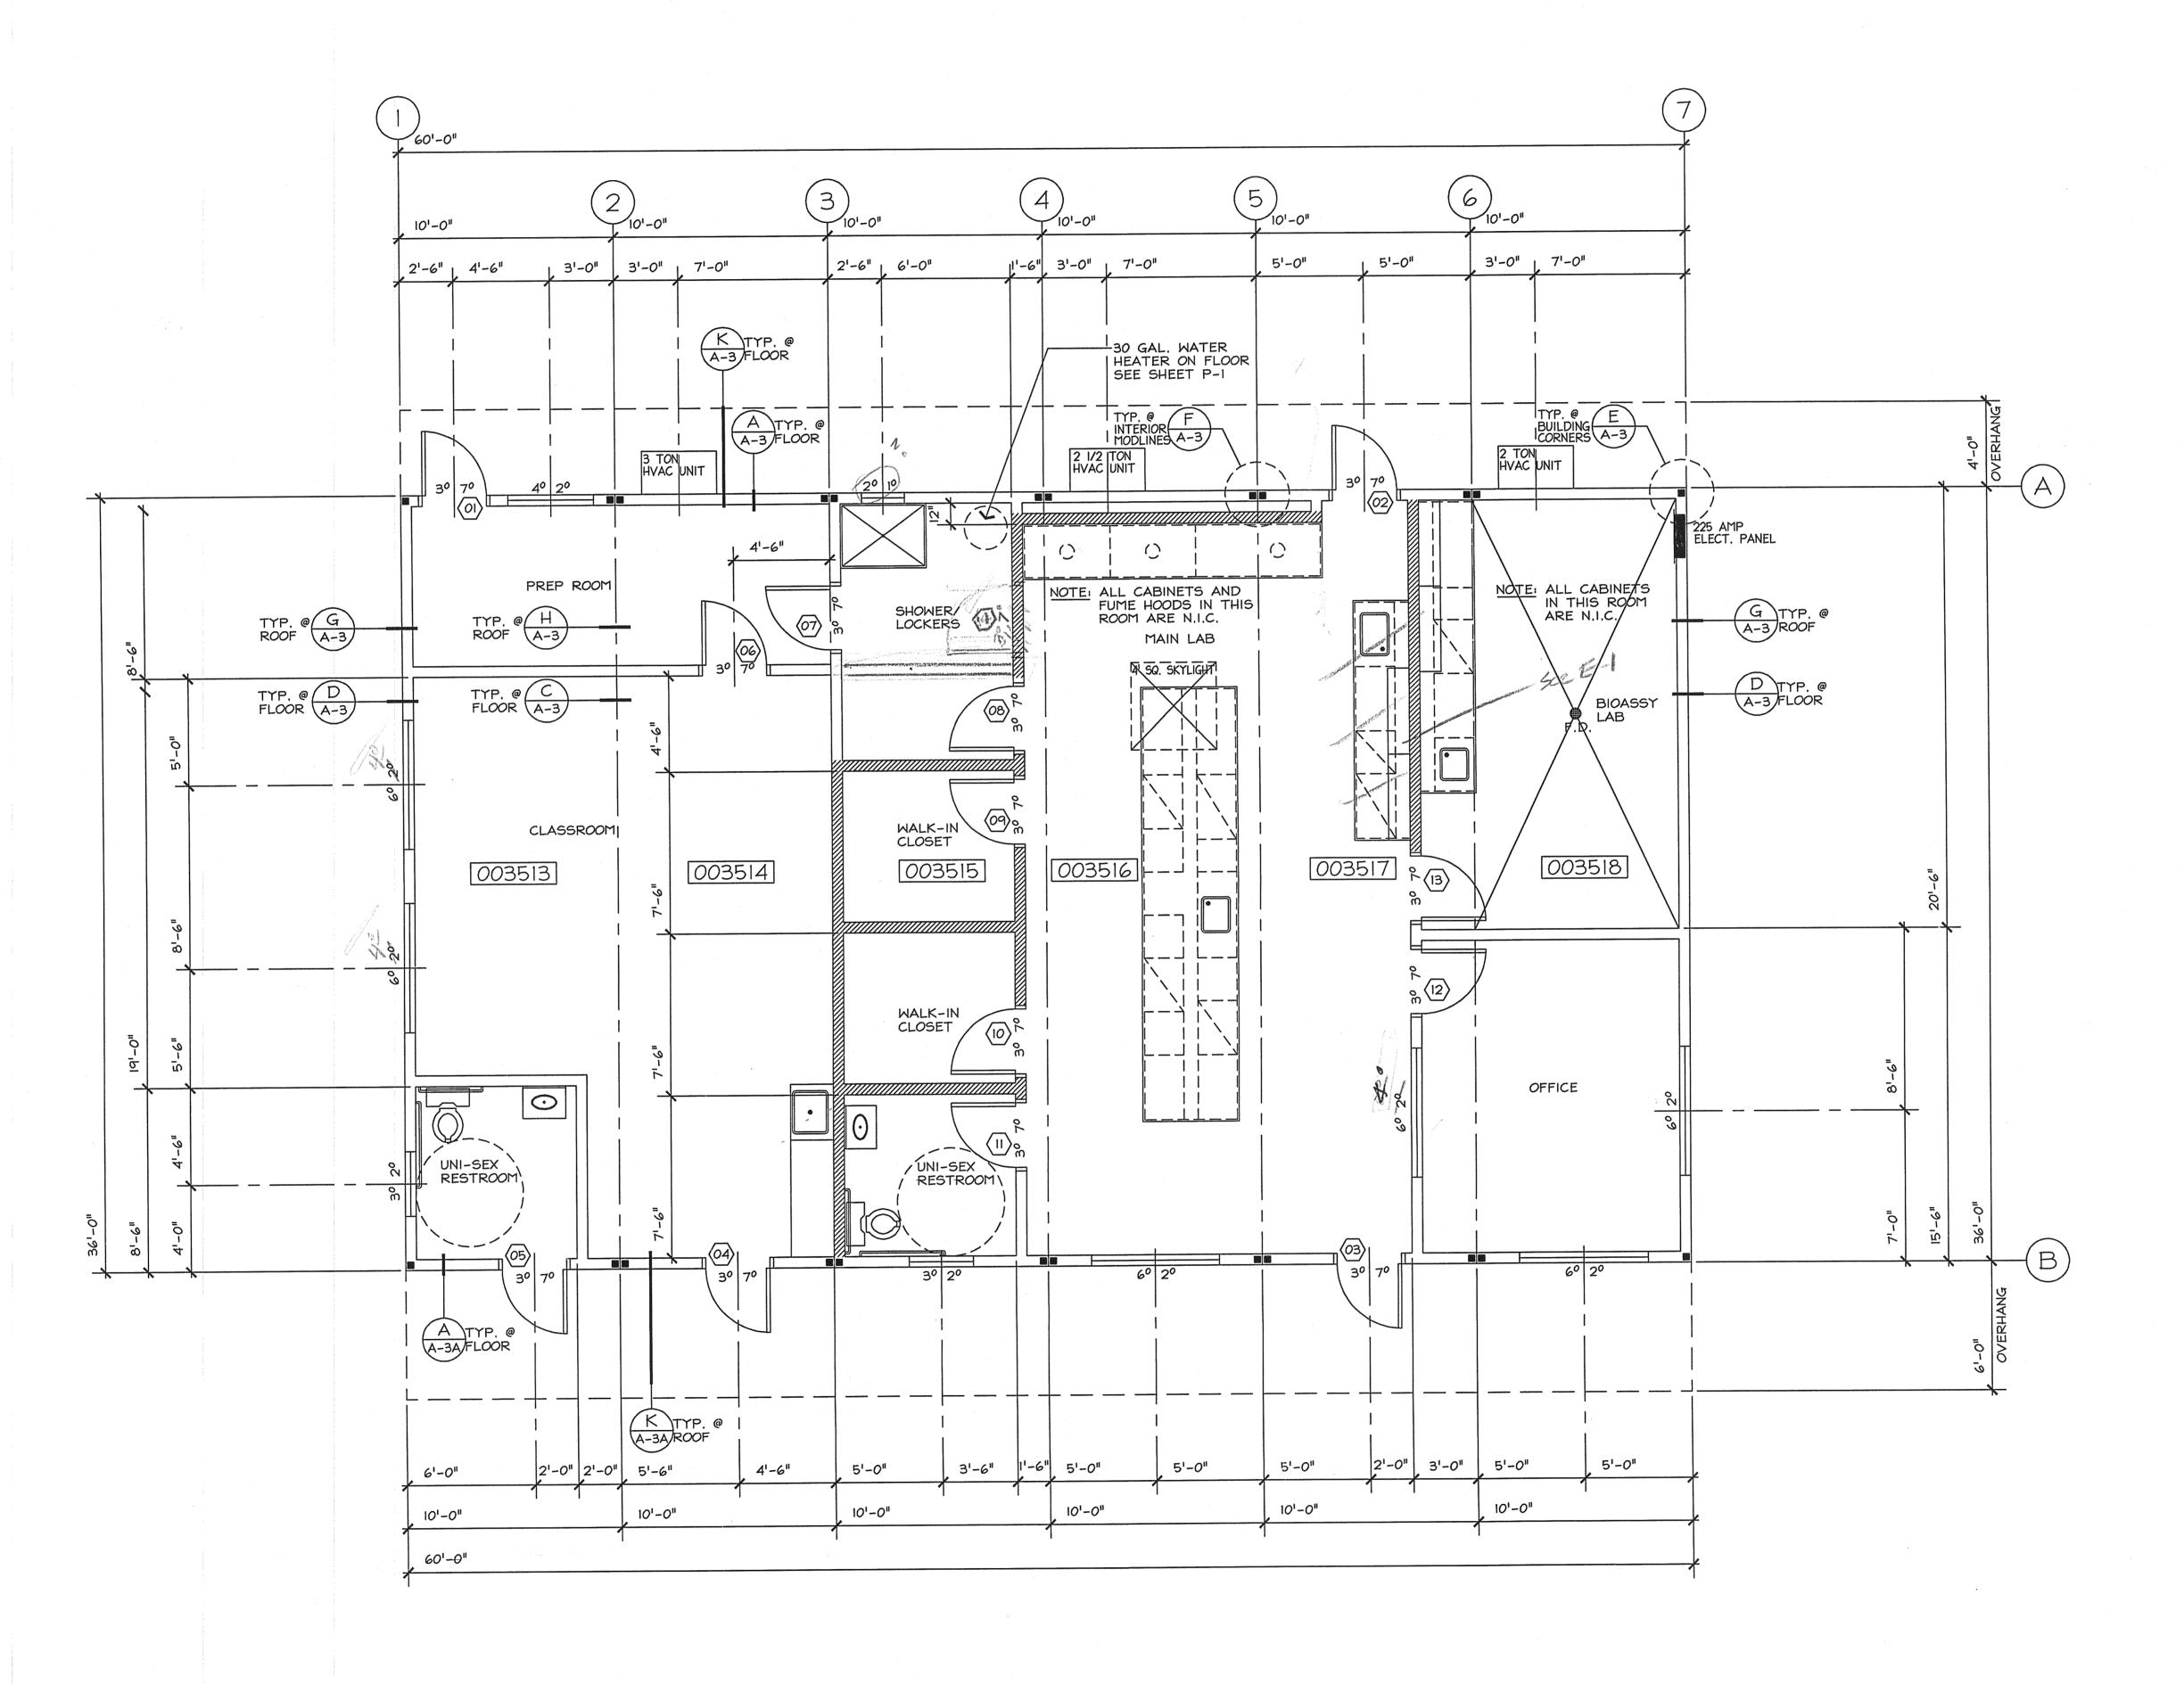


COMPRESSION STRUT DETAIL



SCALE: 1-1/2"=1'-0"

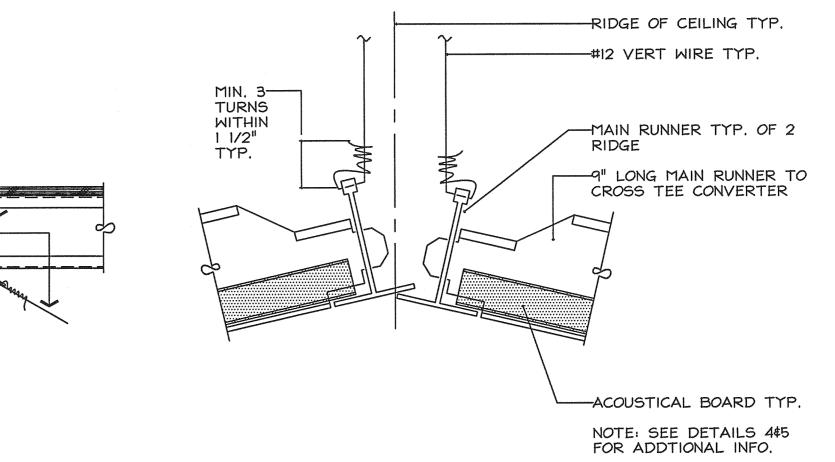

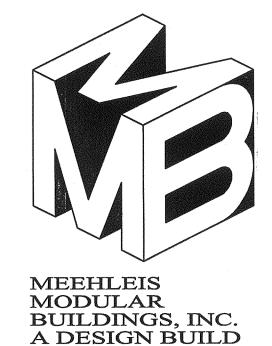

1303 E. LODI AVE. LODI, CA. 95240 (209) 334-4637 CA. LIC. NO. 473488

COMPANY

		C. NO. 3788	7
	ON OFFICE OF THE STATE OF THE S	JULY 24, 2000 KMC	
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	CEILING DETAI	New Building for: Las Gallinas Valley Sanitary District San Rafael, California	
	PRIN	MARRICIO	
	STRUCT	URAL ENGINEER	
	SHI	EET NO.	DB NO.: 00415

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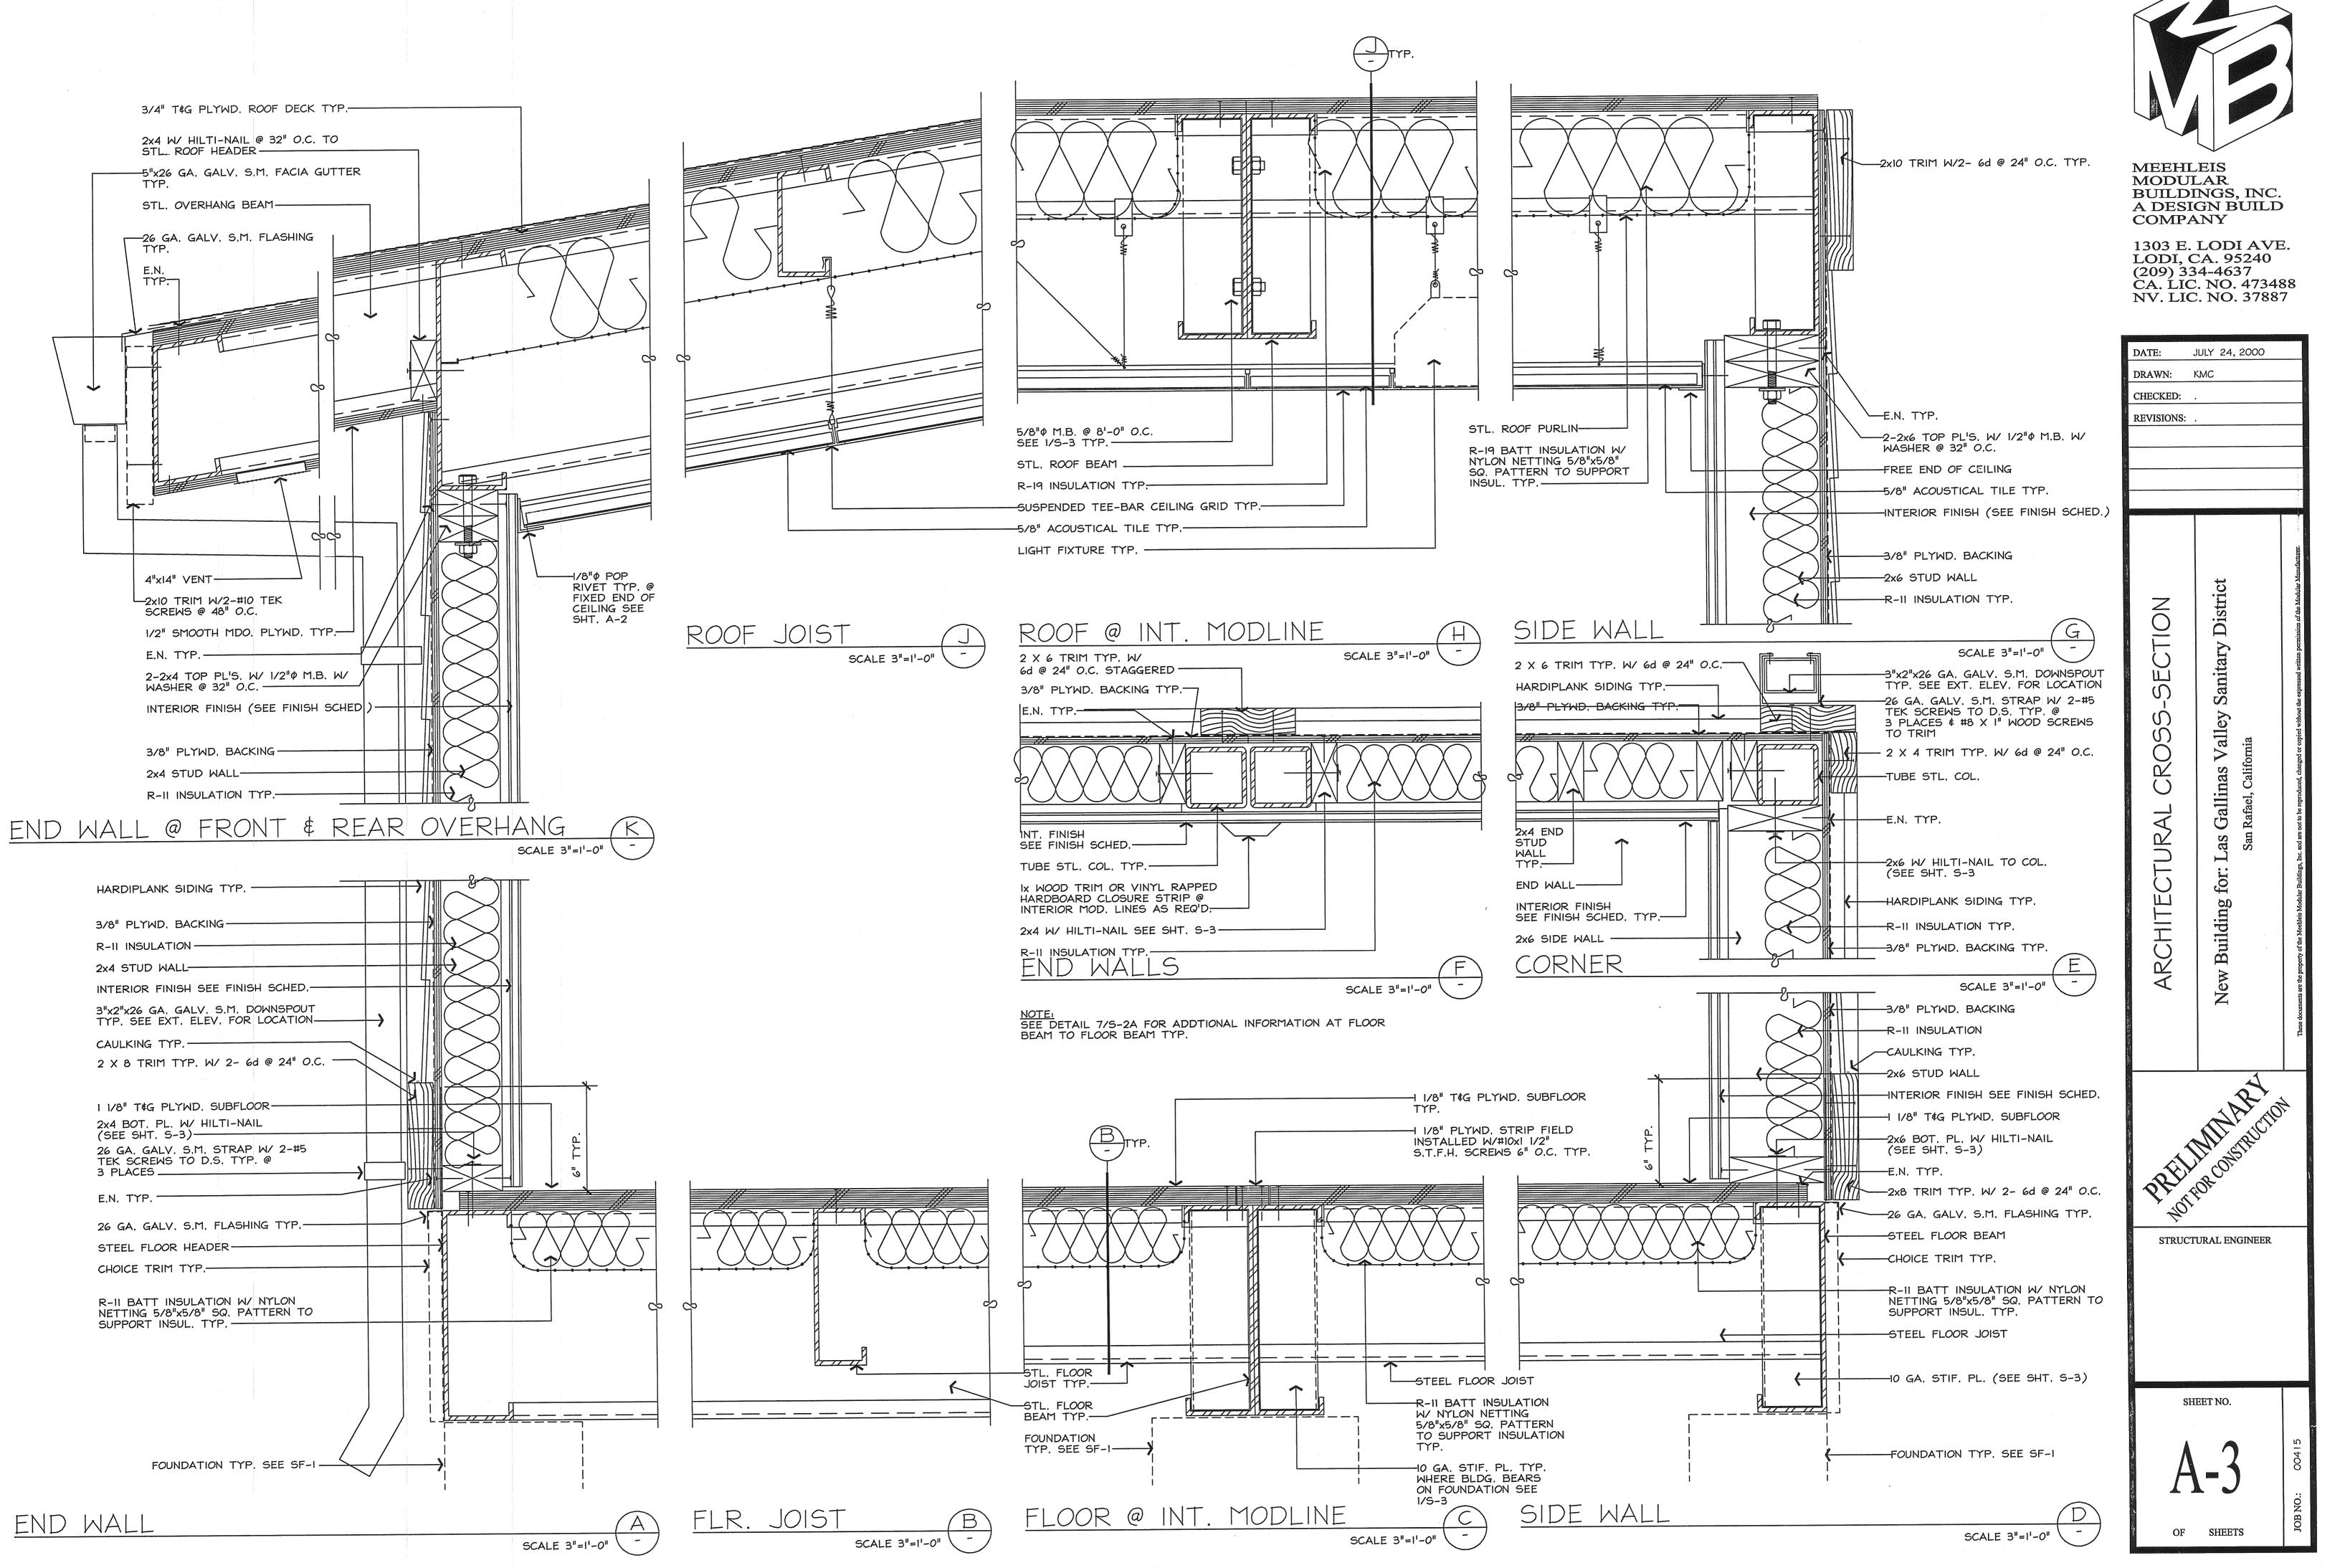
SCALE: 1"=1'-0"

—STL, ROOF PURLIN TYP,—


-12 GA. SPLAY


-1"x2"x12 GA.
METAL CLIP
TYP. W/
#10x3/4"

SELF TAPPING SCREW TO STL.



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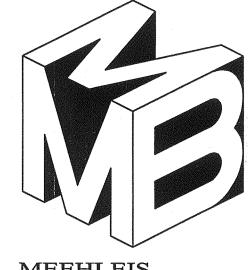


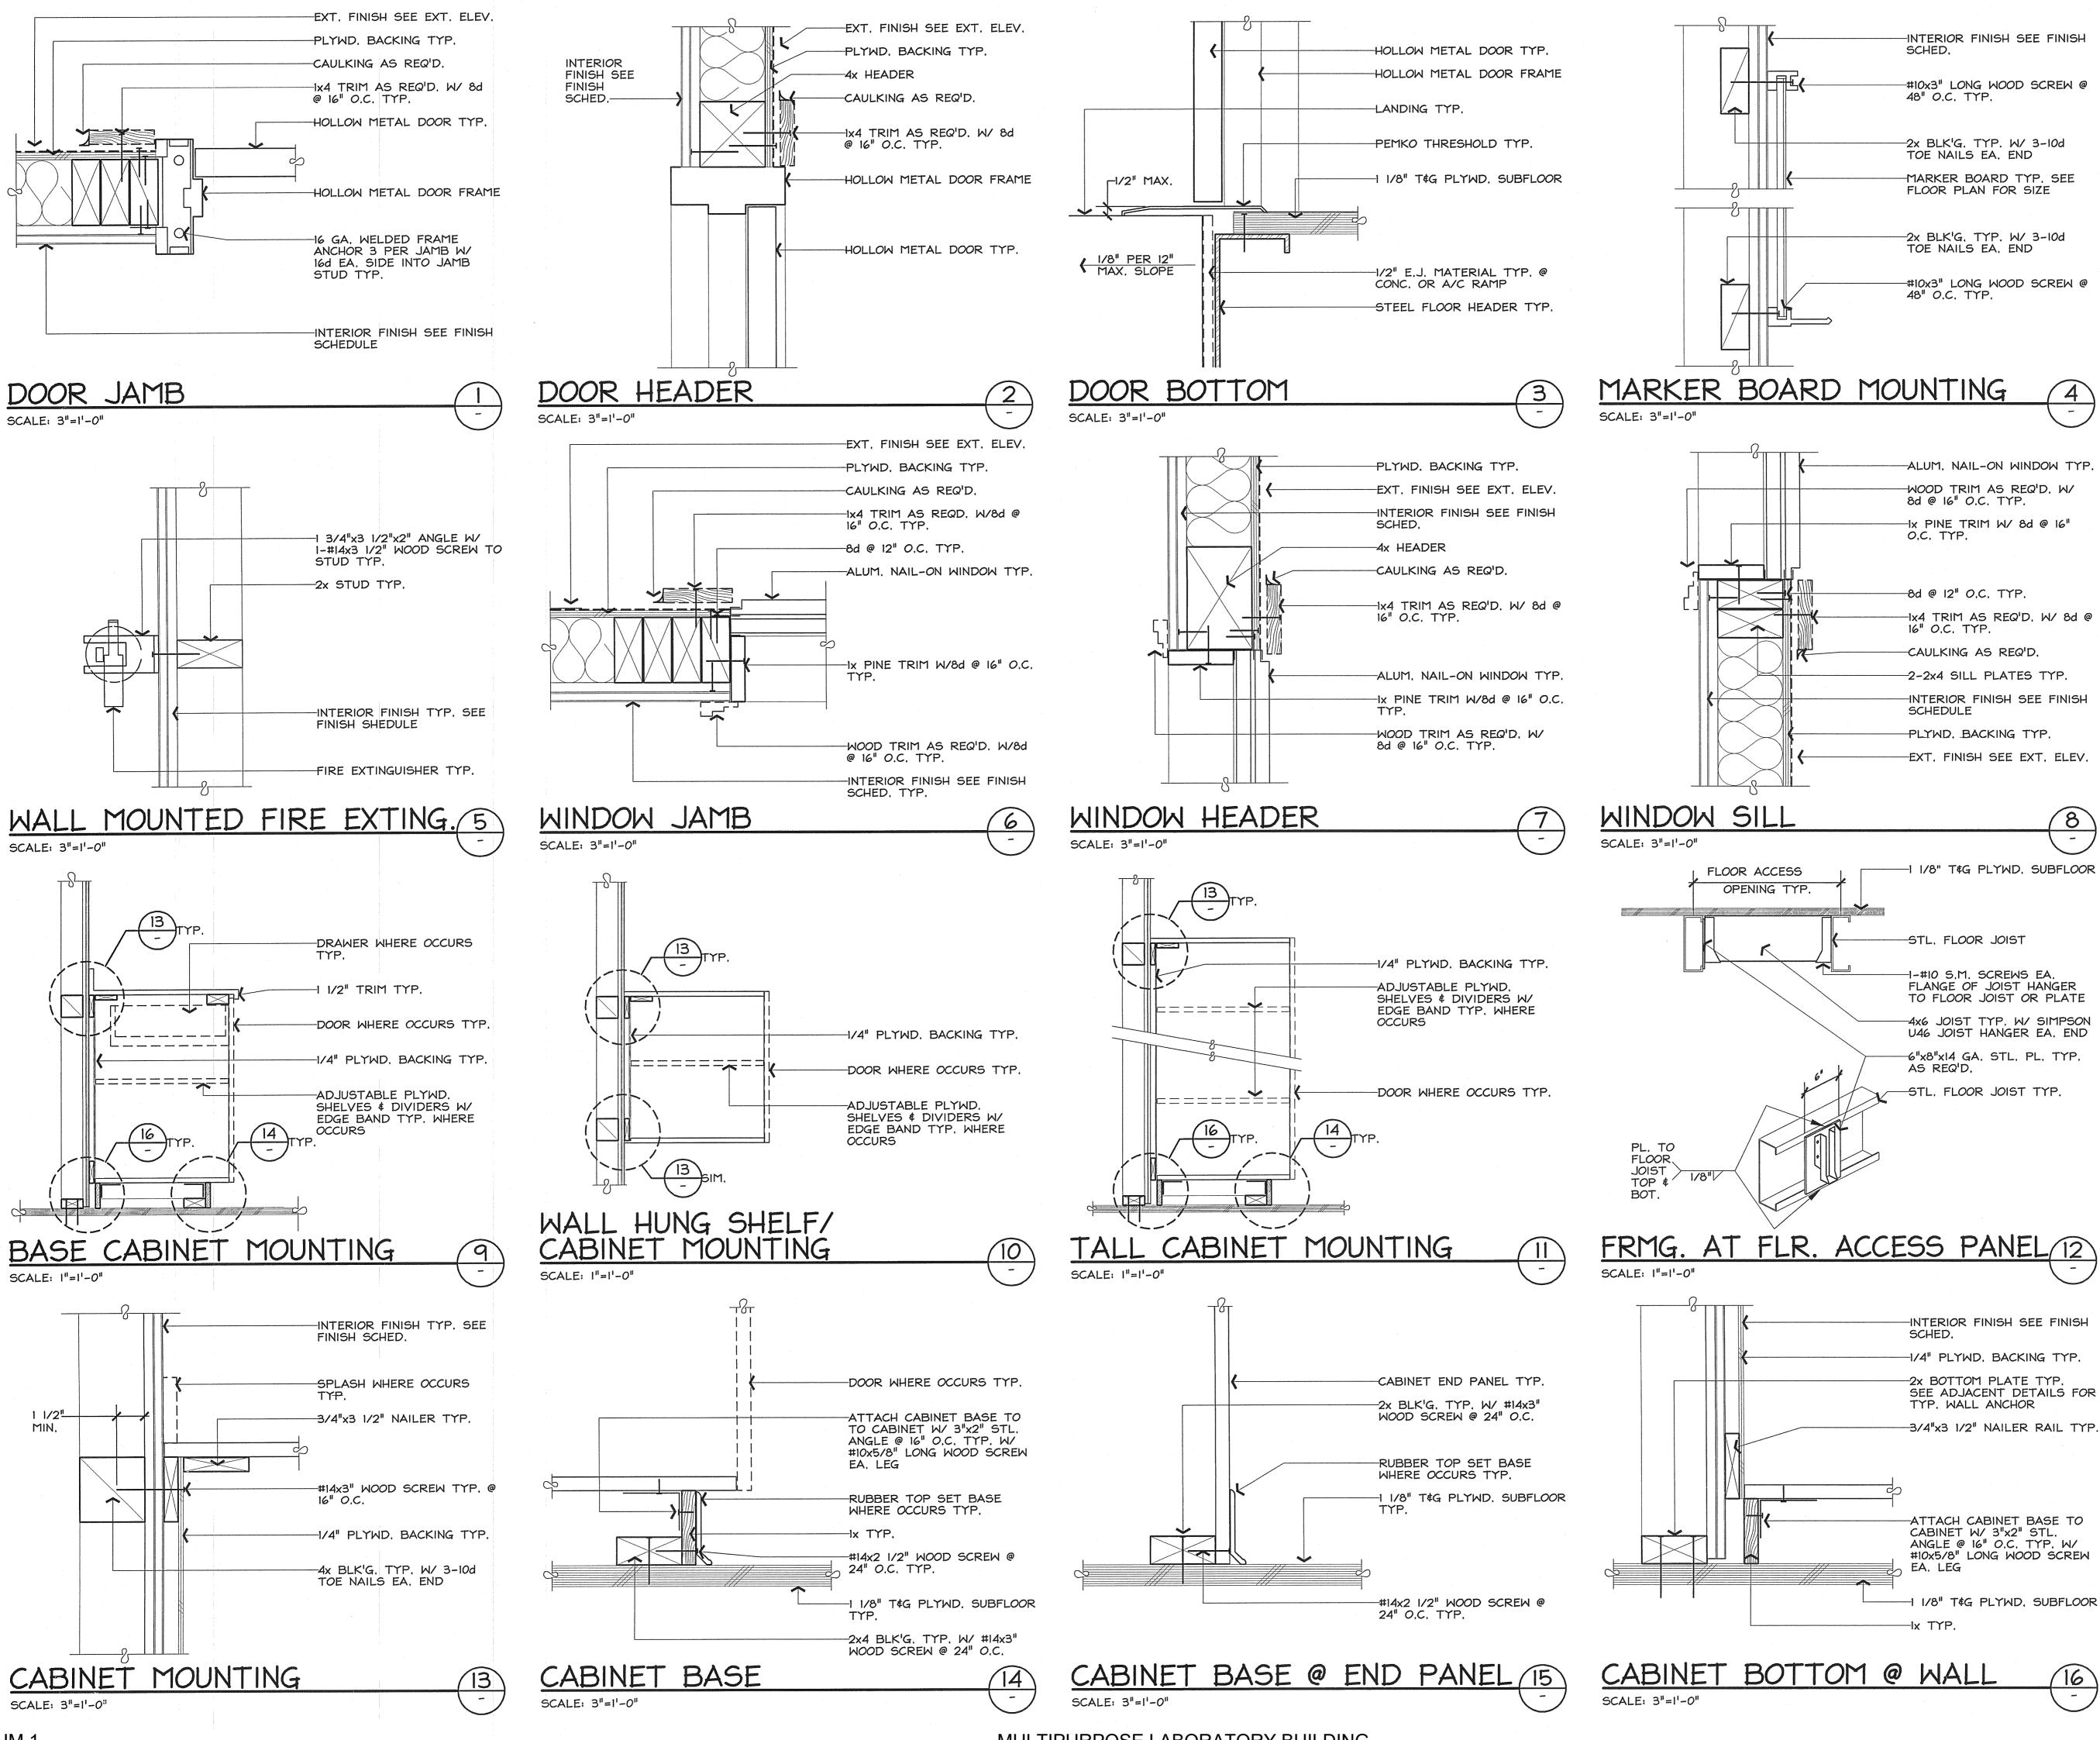1303 E. LODI AVE. LODI, CA. 95240 (209) 334-4637 CA. LIC. NO. 473488 NV. LIC. NO. 37887

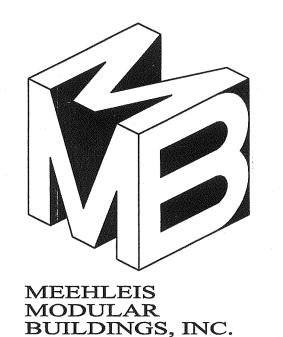A DESIGN BUILD

COMPANY

		JULY 24, 2000 KMC	
	ARCHITECTURAL DETAILS	New Building for: Las Gallinas Valley Sanitary District	These documents are the property of the Meehleis Modular Buildings, Inc. and are not to be reproduced, changed or copied without the expressed written permission of the Modular Manufacturer.
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	STRUCT	URAL ENGINEER	
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MEEHLEIS MODULAR BUILDINGS, INC. A DESIGN BUILD COMPANY


1303 E. LODI AVE. LODI, CA. 95240 (209) 334-4637 CA. LIC. NO. 473488 NV. LIC. NO. 37887


DATE: JULY 24, 2000


DRAWN: KMC

CHECKED:

REVISIONS:

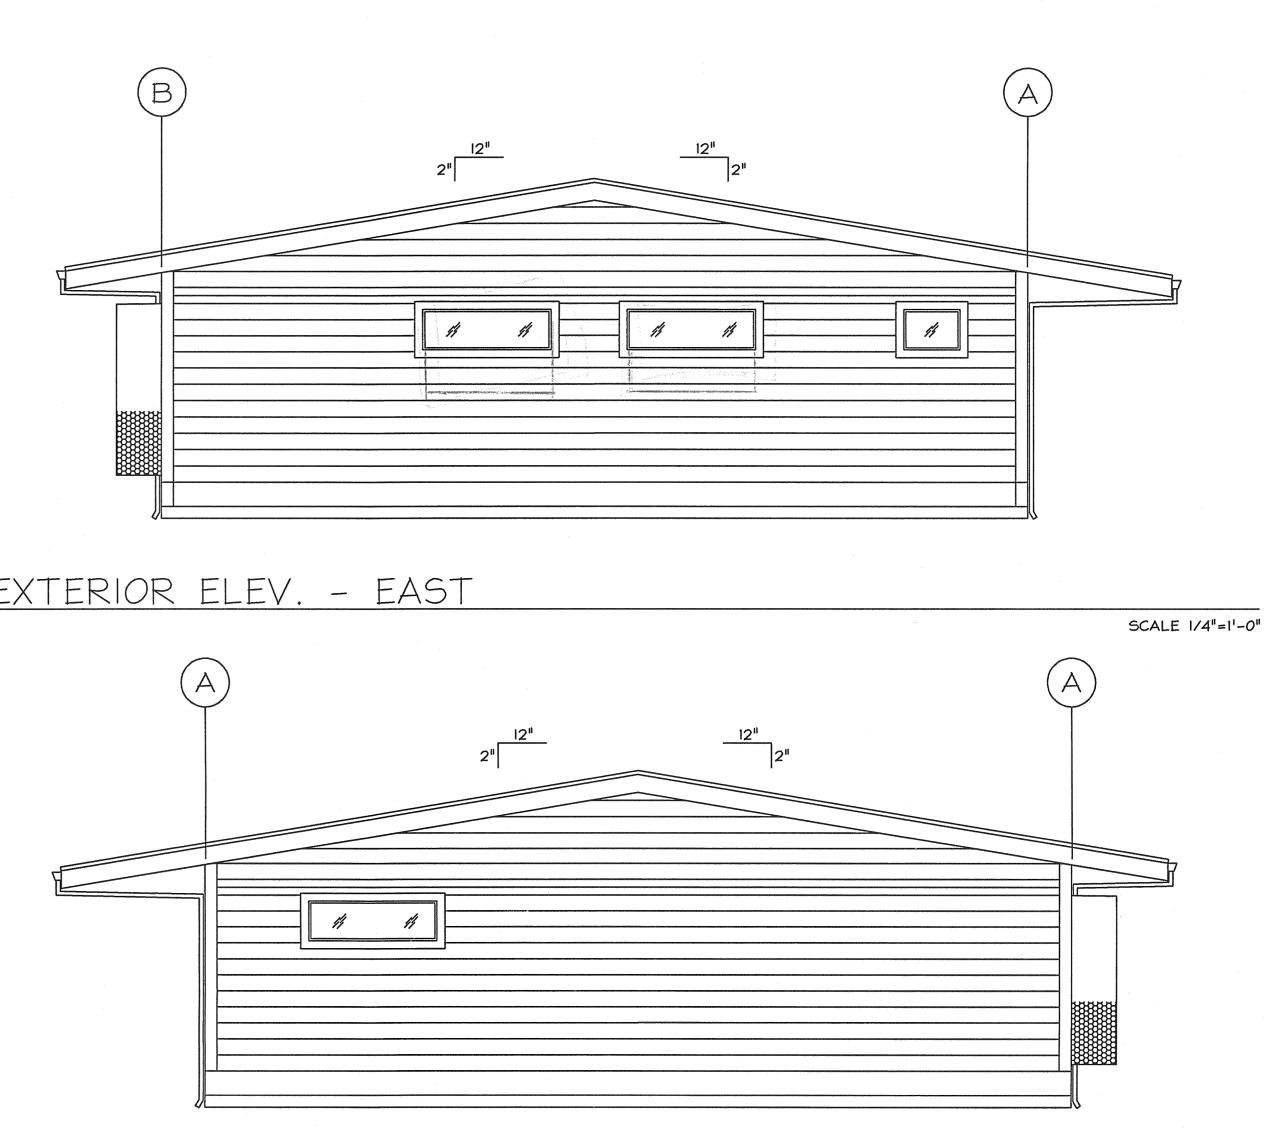

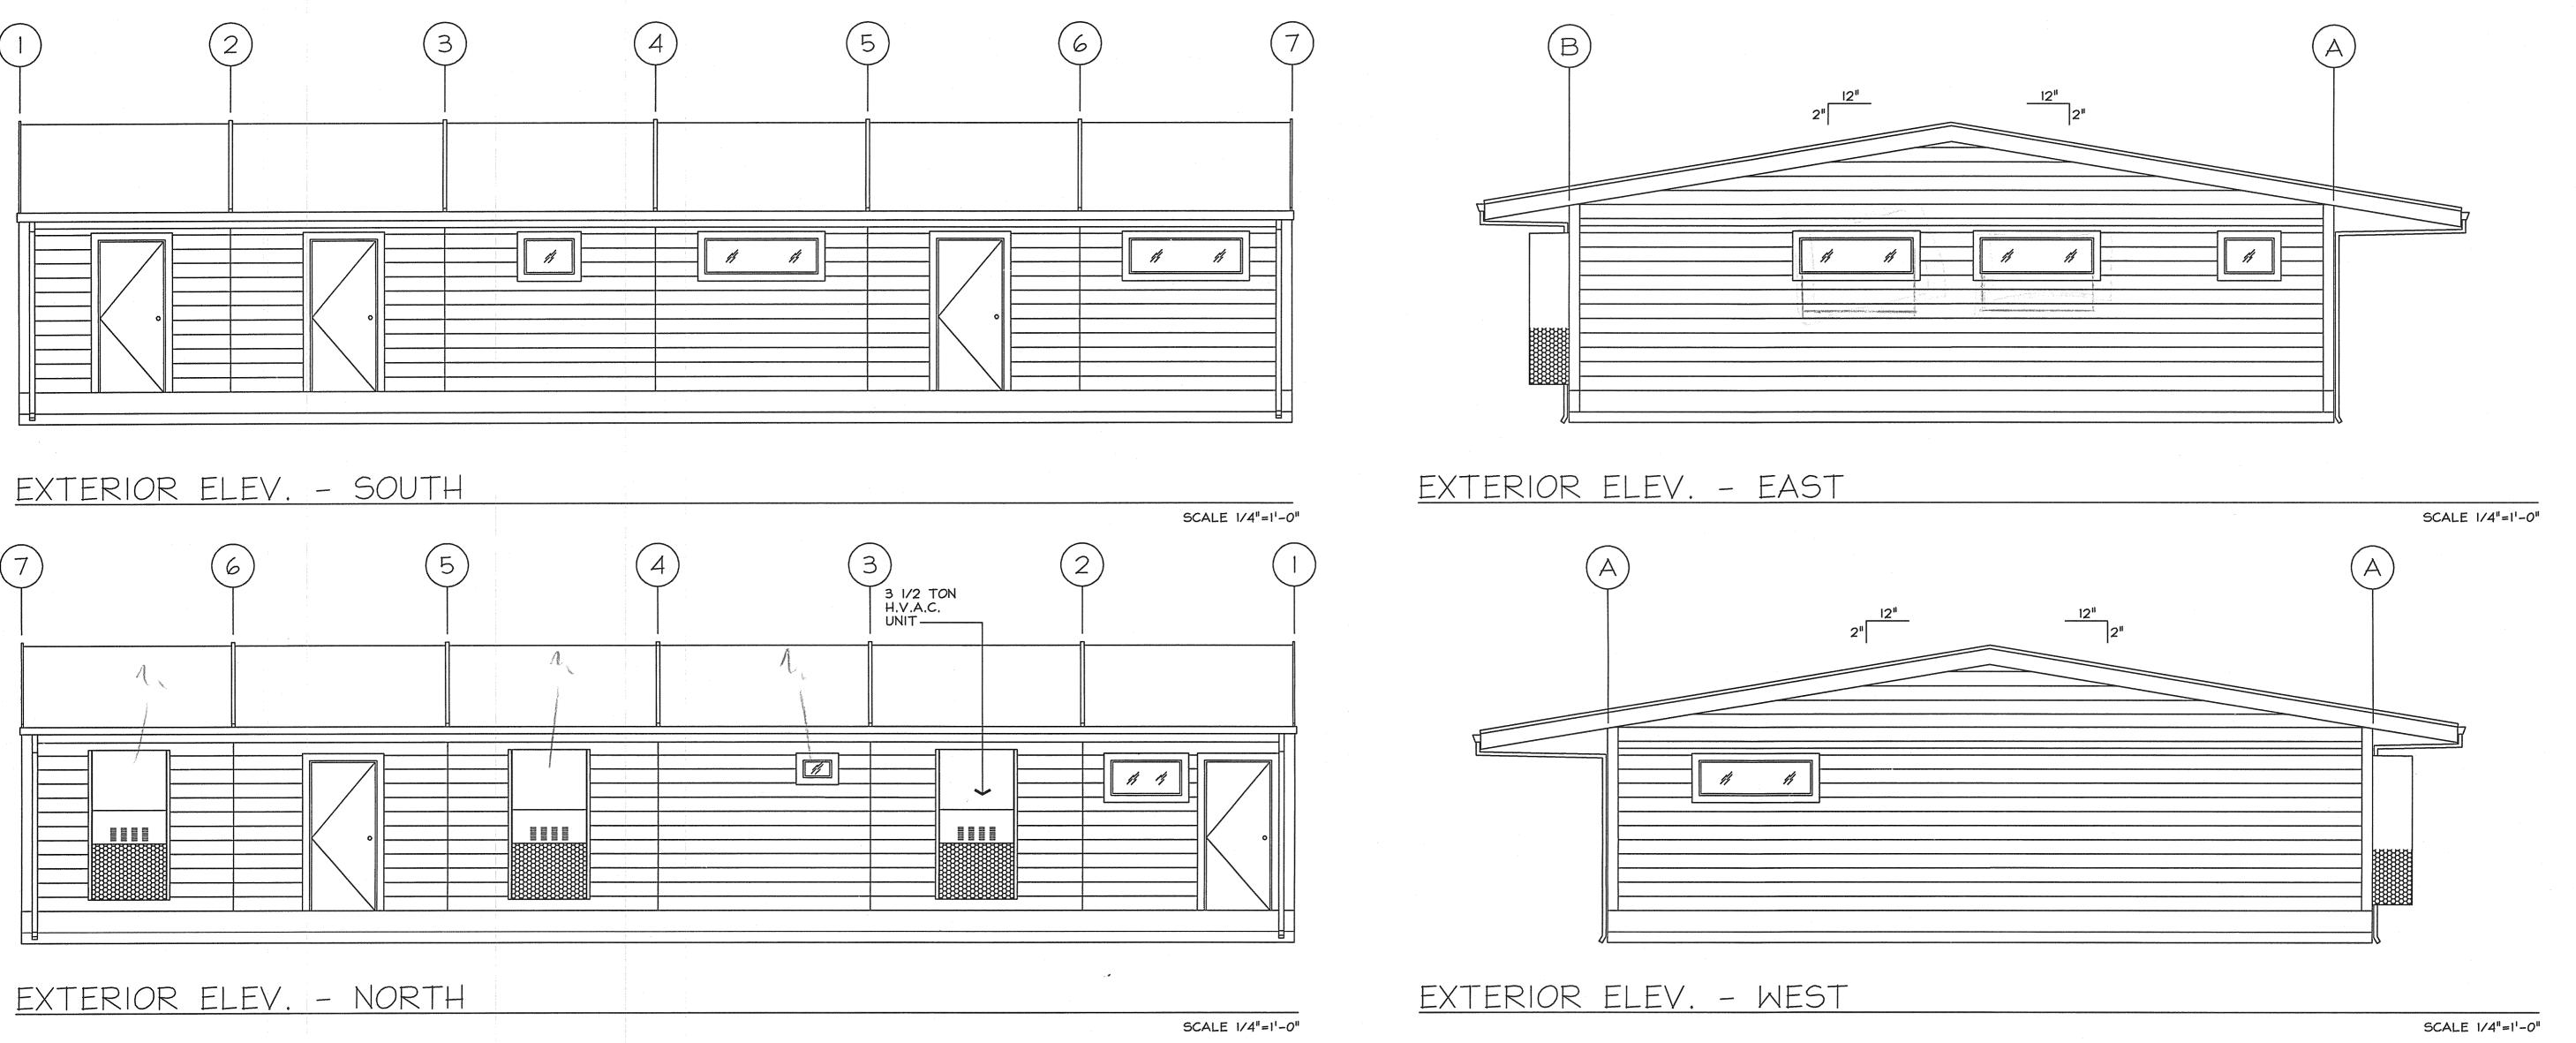

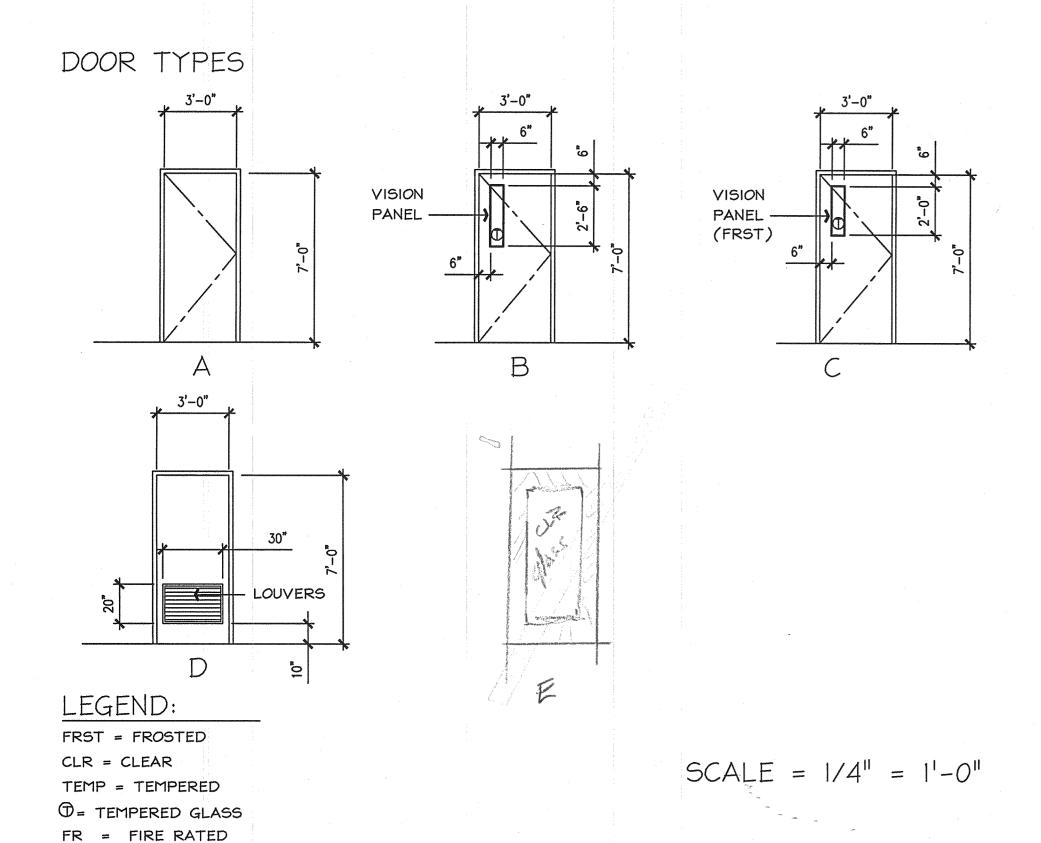

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NO	SIZE	Do	OOR	FR	AME	DE	TAI	LS	HARDWARE		REMARKS
	МхНхТ	TYPE	MAT'L	TYPE	MAT'L	HEAD	JAMB	SILL	GROUP		
01	3'0" X 7'0" X I 3/4'	Α	HM	Α	НМ	2/A-5	I/A-5	3/A-5	·		
02	3'0" X 7'0" X I 3/4'	Α	HM	A.	HM	2/A-5	I/A-5	3/A-5			
03	3'0" X 7'0" X 1 3/4'	Α	HM	A	НМ	2/A-5	I/A-5	3/A-5	***************************************		
04	3'0" X 7'0" X I 3/4'	Α	НМ	Α	НМ	2/A-5	I/A-5	3/A-5			
05	3'0" X 7'0" X I 3/4'	Α	HM	A	НМ	2/A-5	I/A-5	3/A-5			
06	3'0" X 7'0" X I 3/4'	Α	HM	A	HM	2/A-6	I/A-6	N/A			
07	3'0" X 7'0" X I 3/4'	Α	HM	Α	HM	2/A-6	I/A-6	N/A		,	
08	3'0" X 7'0" X I 3/4'	Α	HM	Α	HM	2/A-6					
. 09	3'0" X 7'0" X I 3/4'	Α	HM	A	НМ	2/A-6					
10	3'0" X 7'0" X I 3/4'	Α	HM	A	НМ	2/A-6					
11	3'0" X 7'0" X I 3/4'		HM	A	1111	2/A-6			disconstruction or the contract of the contrac		
12	3'0" X 7'0" X I 3/4'		HM	A	HM	2/A-6					re glass - centre parel
13	3'0" X 7'0" X I 3/4'		HM	Α	HM	2/A-6					
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	· ·		RC		M	FI	NI:	SH	I SCH	IE	DULE
	ROOM	FLOOR	BASE	1,1		ALL M	T		CEILING		REMARKS
		MATERIAL	MATERIAL	2.5	NORTH	WES1	SOUTH	EAS1	MATERIAL	HT.	
	PREP ROOM	AYU	BYZ	Ä,	C I	СІ	СІ	СІ	DΙ	7'-9"	
	CLASSROOM	A 1	ВІ	4"	СІ	СІ	C I	.C 1	DI	7'-9"	
	RESTROOM 1	A 2	B 2	6"	C 2	C 2	C 2	C 2	DI	7'-9"	
Sł	HOWERS/LOCKERS	A 2	B 2	6"	C 2	C 2	C 2	C 2	DΙ	7'-9"	
M	ALK-IN CLOSET I	AYZ	BNZ		CI	СІ	СІ	C I	DΙ	7'-9"	
W	ALK-IN CLOSET 2	AVZ	ВЦБ	4"	C 1	СІ	C I	СІ	DΙ	7'-9"	
	RESTROOM 2	A 2	B 2	6"	C 2	C 2	C 2	C 2	DΙ	7'-9"	
	MAIN LAB	MAZ	BNZ	Ail	СІ	СІ	СІ	СІ	DI	VARIES 7'-9" MIN. 10'-9" MAX.	
-	BIOASSY LAB	AL/12	BIL	4"	C 1	СІ	СІ	C I	DI	7'-9"	
	OFFICE	A 1	ВІ	4"	C I	СІ	СІ	C I	DΙ	7'-9"	

FLOOR FINISHES

AI CARPET A2 SHEET VINYL BASE FINISHES

BI 4" RUBBER TOPSET BASE B2 6" SHEET VINYL COVED

WALL FINISHES

CI VINYL COVERED TACKBOARD O/ GYPSUM WALL BOARD


C2 1/8" F.R.P. O/ WATER RESISTANT GYPSUM WALL BOARD


CEILING FINISHES

DI DROP-IN ACOUSTICAL TILES IN A SUSPENDED T-BAR GRID SYSTEM

FINISH MATERIAL NOTES:

CEILING FINISHES TO HAVE A FLAME SPREAD OF 0-25, AND A SMOKE DENSITY LESS THAN 450. WALL FINISHES TO HAVE A FLAME SPREAD RATING OF CLASS III 76-200, AND A SMOKE DENSITY LESS THAN 450. FLOOR FINISHES TO HAVE A SMOKE DENSITY LESS THAN 450.

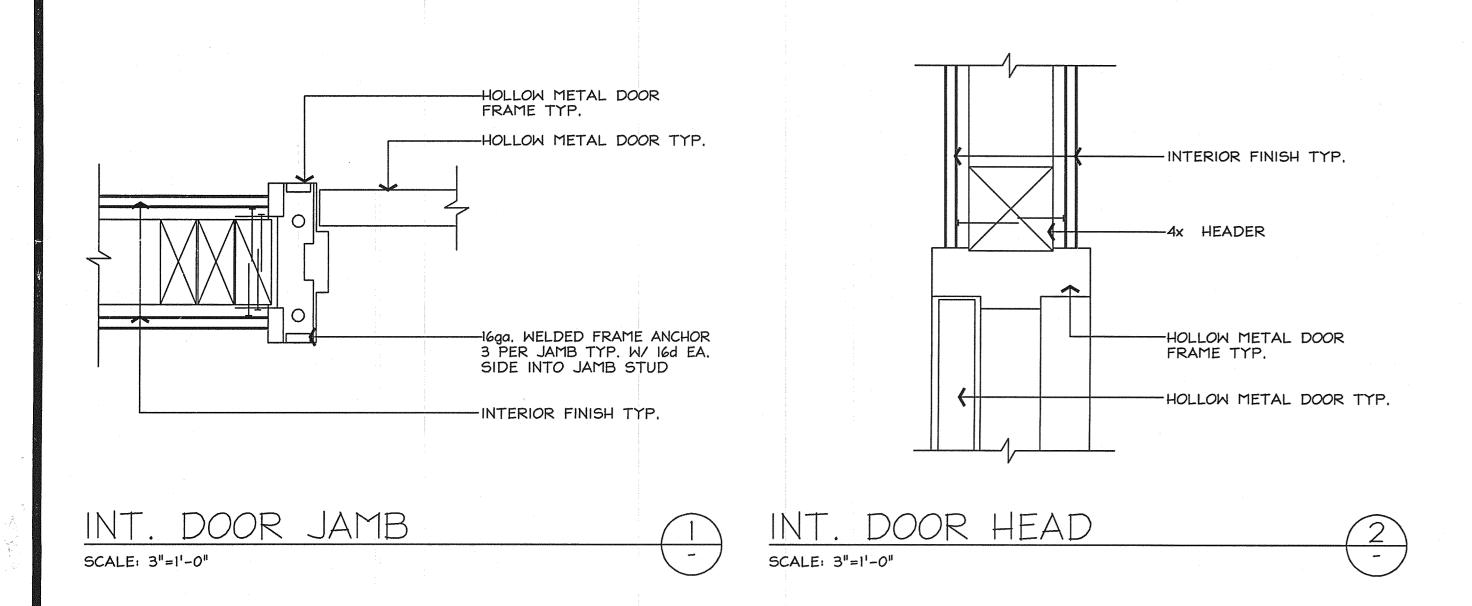

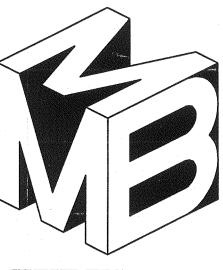


MEEHLEIS MODULAR BUILDINGS, INC. A DESIGN BUILD COMPANY

1303 E. LODI AVE. LODI, CA. 95240 (209) 334-4637 CA. LIC. NO. 473488 NV. LIC. NO. 37887

DATE: JUNE 12, 2000

	DRAWN:	BLB	1
	CHECKED:		
	REVISIONS:		
			3
			;
	INT. FINISH SCHEDULE & DOOR SCHEDULE	New Building for: Las Gallinas Valley Sanitary District San Rafael, California	These documents are the property of the Meehleis Modular Buildings, Inc. and are not to be reproduced, changed or copied without the expressed written permission of the Modular Manufacturer.
	STRUCTU	TRAL ENGINEER	
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		_6	JOB NO.: 00415
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SOIL, FOUNDATION, AND CONCRETE NOTES:

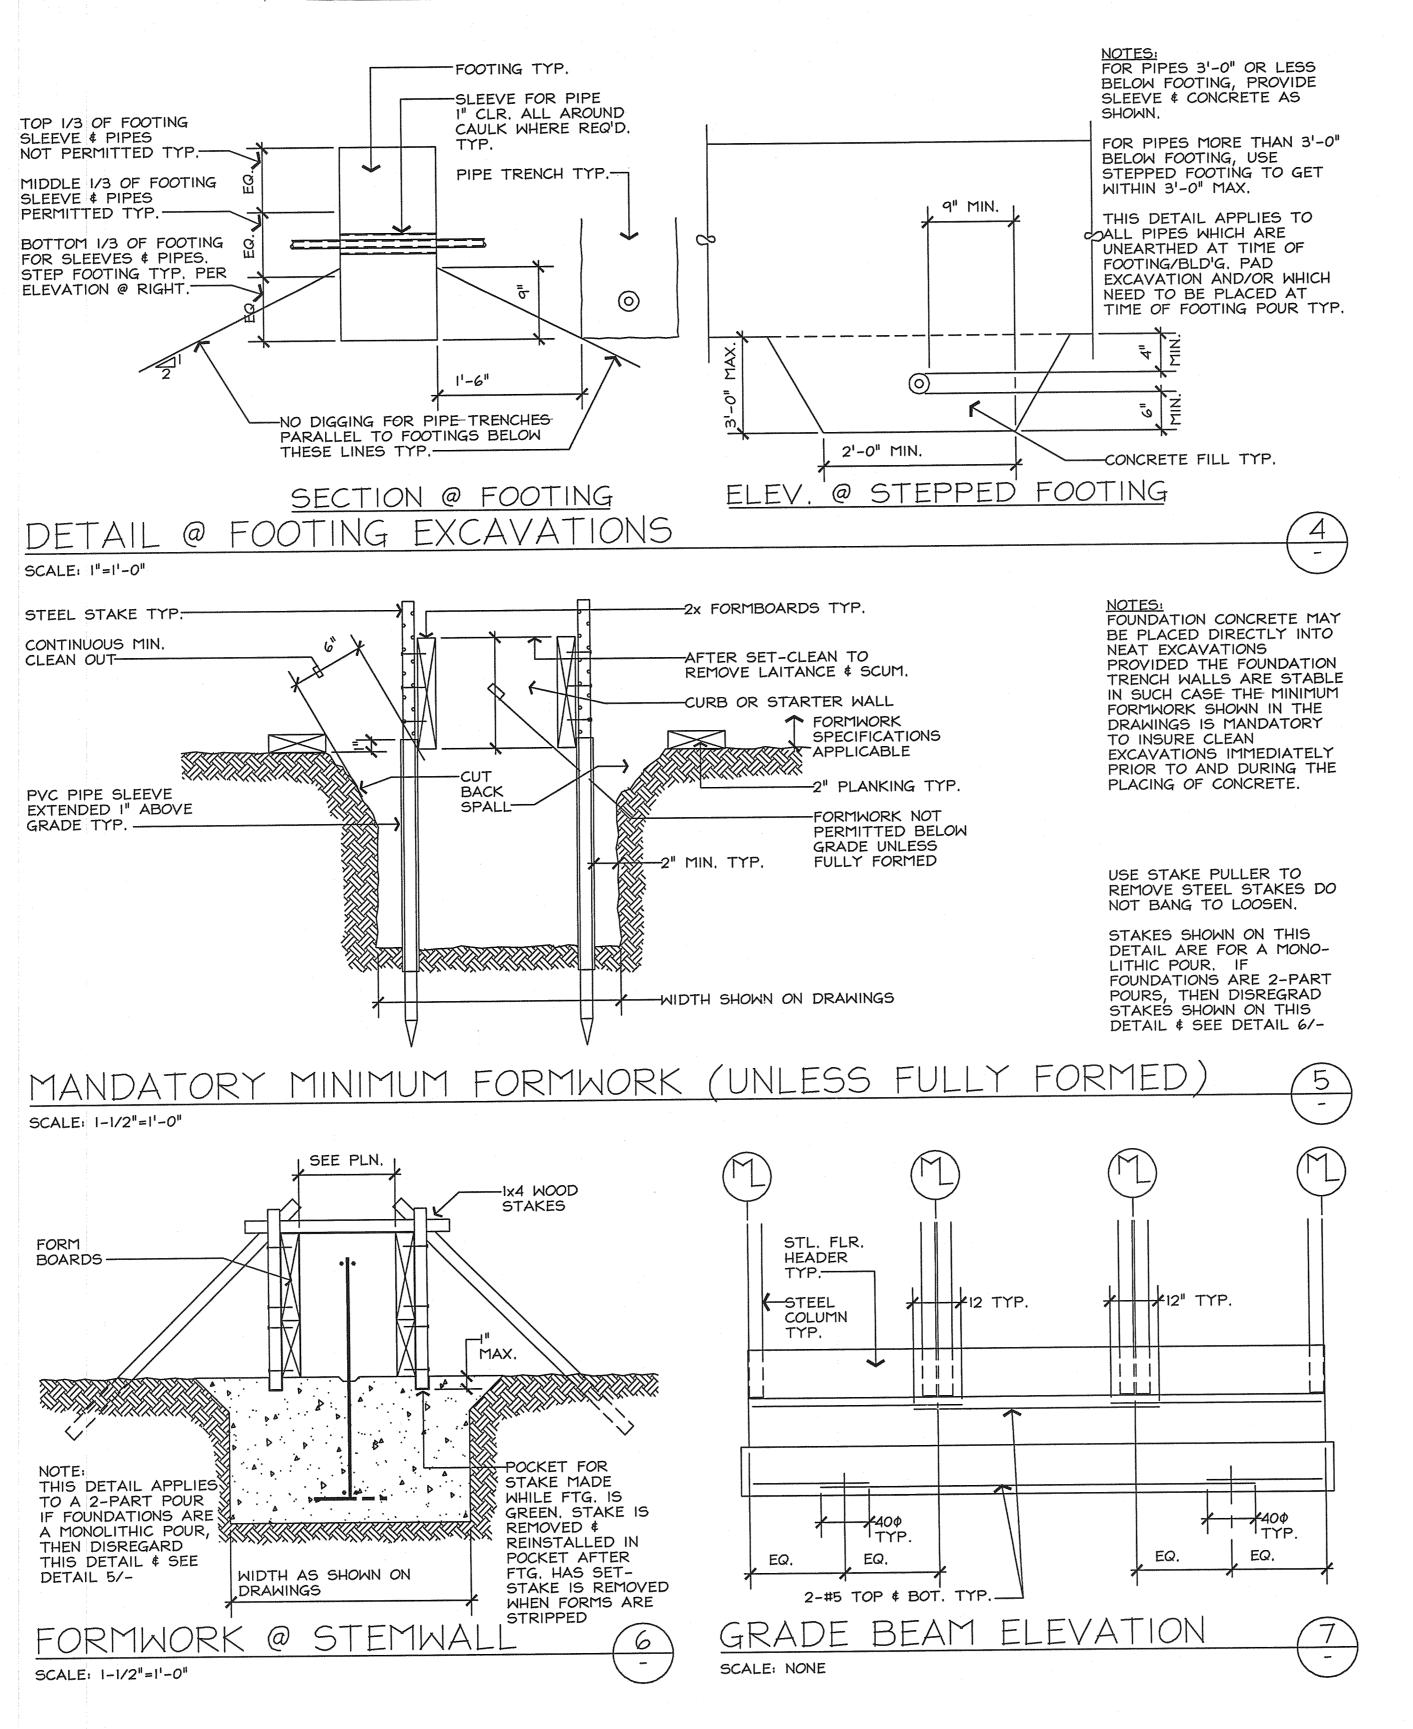1. SOIL TYPE AND FOUNDATION:

A. SOIL BEARING VALUE: 1,000 P.S.F.

B. MINIMUM DEPTH
ALL FOOTING SHALL EXTEND A MINIMUM OF 12" INCHES INTO
NATURAL GROUND OR 12 INCHES INTO APPROVED, COMPACTED FILL.

2. COMPACTED FILL:

ALL FILL MATERIAL SHALL BE COMPACTED IN PLACE TO A MINIMUM RELATIVE DENSITY OF 90%, AREA TO RECEIVE FILL SHALL BE CLEARED AND SCARIFIED.

3. CONCRETE:

ALL CONCRETE SHALL HAVE A MINIMUM STRENGTH OF F'C=2,500 P.S.I.

(DESIGN BASED OF F'C=2,500 P.S.I.) AFTER 28 DAYS

PER TITLE 24 WITH WEIGH MASTERS CERTIFICATE AND TEST CYLENDERS TO BE PROVIDED. ALL CEMENT SHALL BE TYPE I OR TYPE II PER A.S.T.M.

C-150 AGGREGATE 3/4" TO 1" MAXIMUM SIZE BUT NOT MORE THAN 3/4 OF MIN. CLEAR BAR SPACING.

4. REINFORCING STEEL:

A. MATERIAL:
ALL REINFORCING STEEL SHALL BE BILLET STEEL PER A.S.T.M.
A615 GRADE 40.


B. SPLICES: %U
ALL SPLICES SHALL BE LAPPED A MINIMUM OF 40 DIAMETERS OR 2'-0" WHICHEVER IS GREATER.

C. REINFORCING FABRICATION AND PLACEMENT:
FABRICATION AND PLACING OF REINFORCING STEEL SHALL CONFORM TO THE
"CODE OF STANDARD PRACTICE" AND SPECIFICATIONS FOR PLACING


D. MINIMUM COVERAGE: ALL REINFORCING SHALL HAVE THE FOLLOWING MINIMUM COVERAGE WITH CONCRETE,

REINFORCEMENT" OF THE CONCRETE REINFORCING STEEL INSTITUTE.

LOCATION FORMED EARTH UNFORMED EARTH AMOUNT 2" 3"

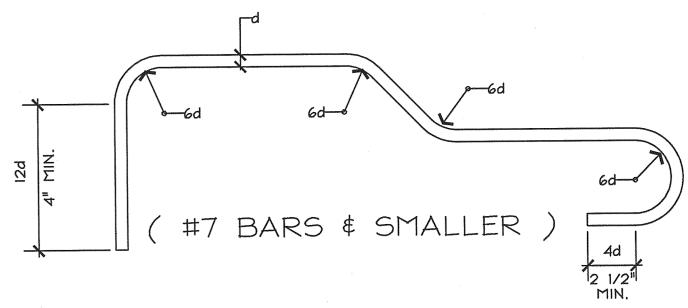


TYP. REINFORCING BAR BENDING

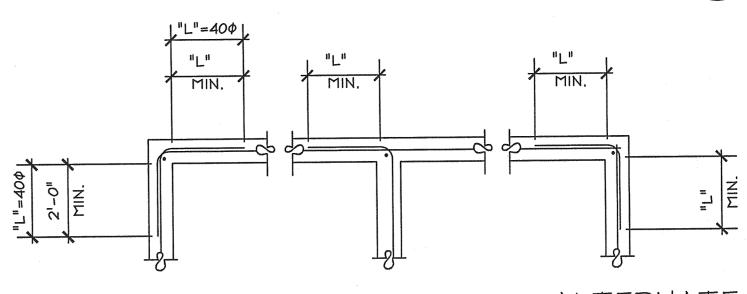

CORNER

INTERSECTION

ALTERNATE

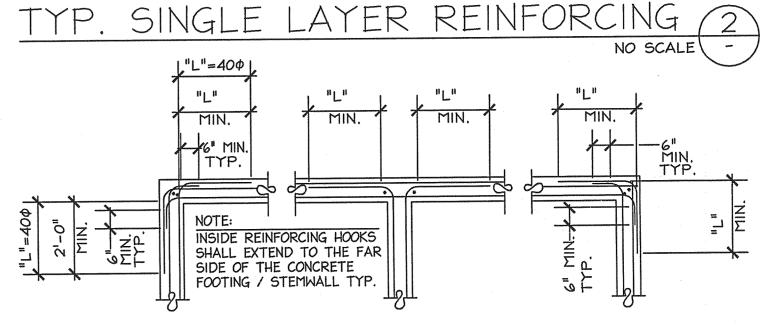


CORNER

INTERSECTION


ALTERNATE CORNER


TYP. DOUBLE LAYER REINFORCING

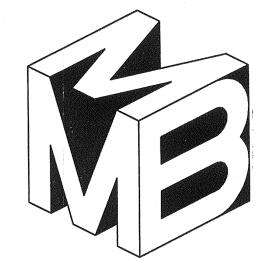

MEEHLEIS MODULAR BUILDINGS, INC. A DESIGN BUILD COMPANY


D		JUNE 12, 2000 BLB	
	SOIL WITH CONCRETE NOTES	New Building for: Las Gallinas Valley Sanitary District San Rafael, California	These documents are the property of the Meehleis Modular Buildings, Inc. and are not to be reproduced, changed or copied without the expressed written permission of the Modular Manufacturer.
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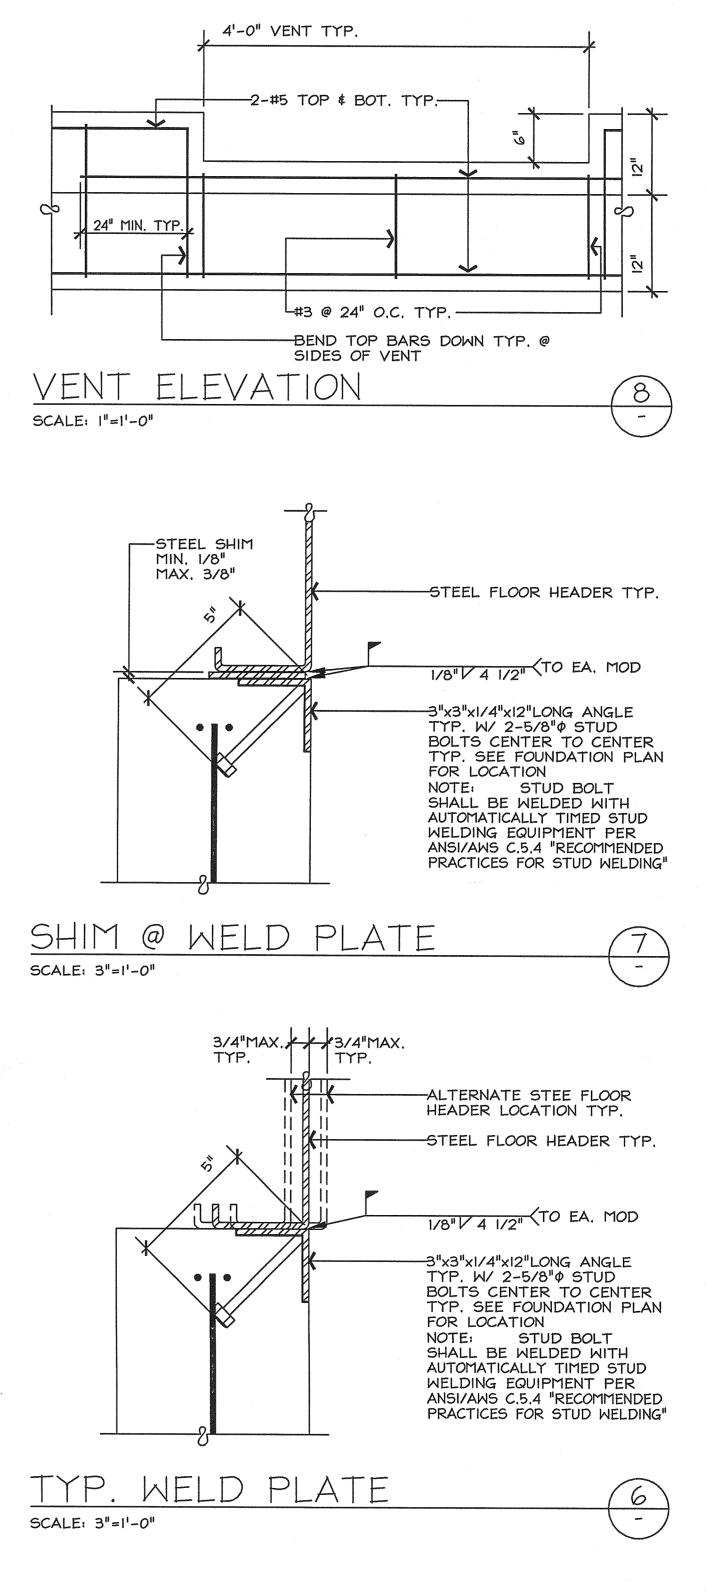


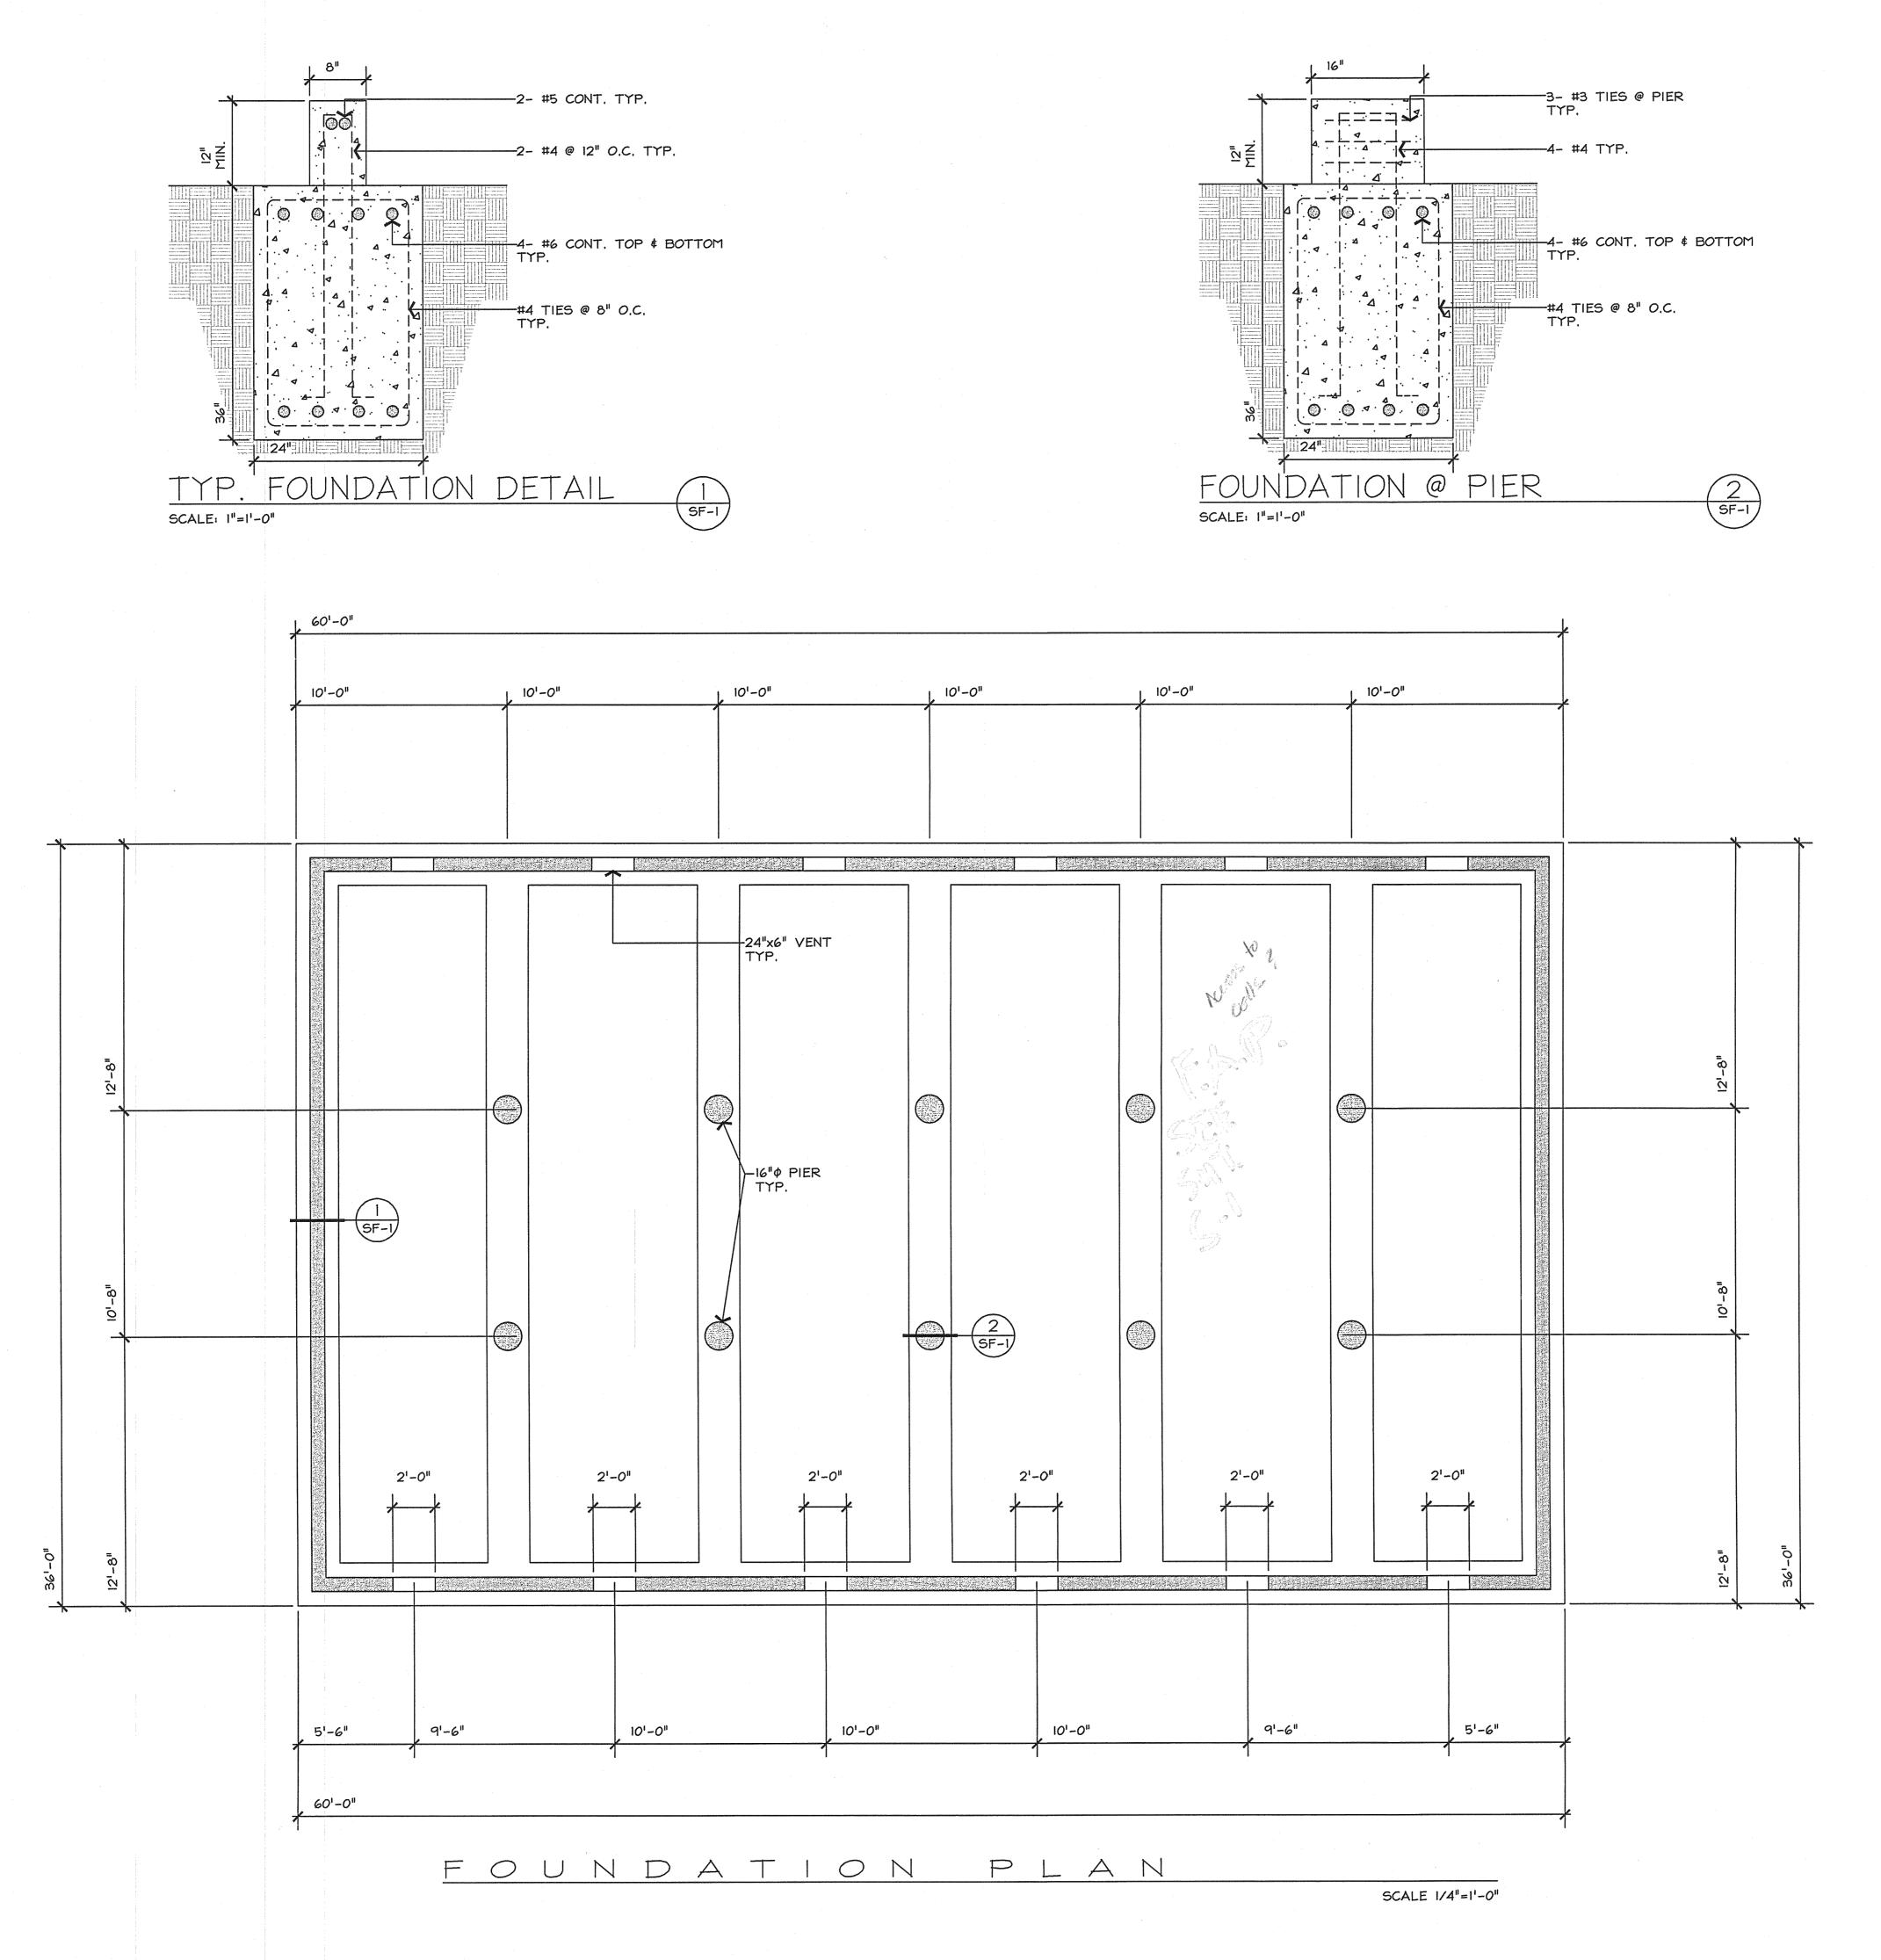MEEHLEIS MODULAR BUILDINGS, INC. A DESIGN BUILD COMPANY

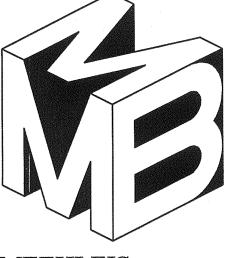
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	WITH DET	New Building for: Las Gallinas Valley Sanitary District San Rafael, California	These documents are the property of the Mechleis Mochilar Buildings, Inc. and are not to be reproduced, changed or copied without the expressed written permission of the Mochilar Manufacturer.
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POUNDATION PLAN WITH DETAILS New Building for: Las Gallinas Valley Sanitary District San Rafael, California These documents are the property of the Meetidist Modular Buildings, Inc. and are not to be reproduced, changed or copied without the expressed written permission of the Modular Manufacture.	POUNDATION PLAN WITH DETAIL New Building for: Las Gallinas Valley Sanitary D San Rafael, California These documents are the property of the Meebleis Modular Buildings, Inc. and are not to be reproduced, changed or copied without the expressed written permission
	STRUCTURAL ENGINEER
	STRUCTURAL ENGINEER




2. AS AN ALTERNATE TO #10 x 1 1/2"
F.H. SELF TAP SCREWS @ PLYWOOD
TO FLOOR FRAMES PROVIDE ERICO
PINS #AKN-144-0175 0.1440 x 1 3/4"
LONG TYP. @ SAME SPACING AS PER
#10 x 1 1/2" SCREWS SEE 1.C.B.O.
REPORT #4144 DATED DEC. 1,1995.

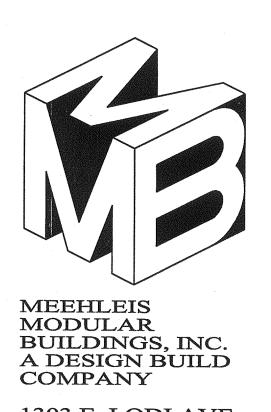

MEEHLEIS MODULAR BUILDINGS, INC. A DESIGN BUILD COMPANY

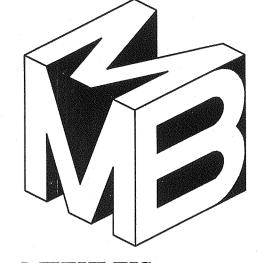1303 E. LODI AVE. LODI, CA. 95240 (209) 334-4637 CA. LIC. NO. 473488 NV. LIC. NO. 37887

	DATE:	JULY 24, 2000	
	DRAWN:	KMC	***************************************
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	REVISIONS:		·····
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	FLOOR FRAMING PLAN WITH MEMBER SCHEDULE	New Building for: Las Gallinas Valley Sanitary District	These documents are the property of the Meehleis Modular Buildings, Inc. and are not to be reproduced, changed or received without the expressed written permission of the Modular Manufacturer.
	PRICE	MANUAL ENGINEER	
	SH	EET NO.	

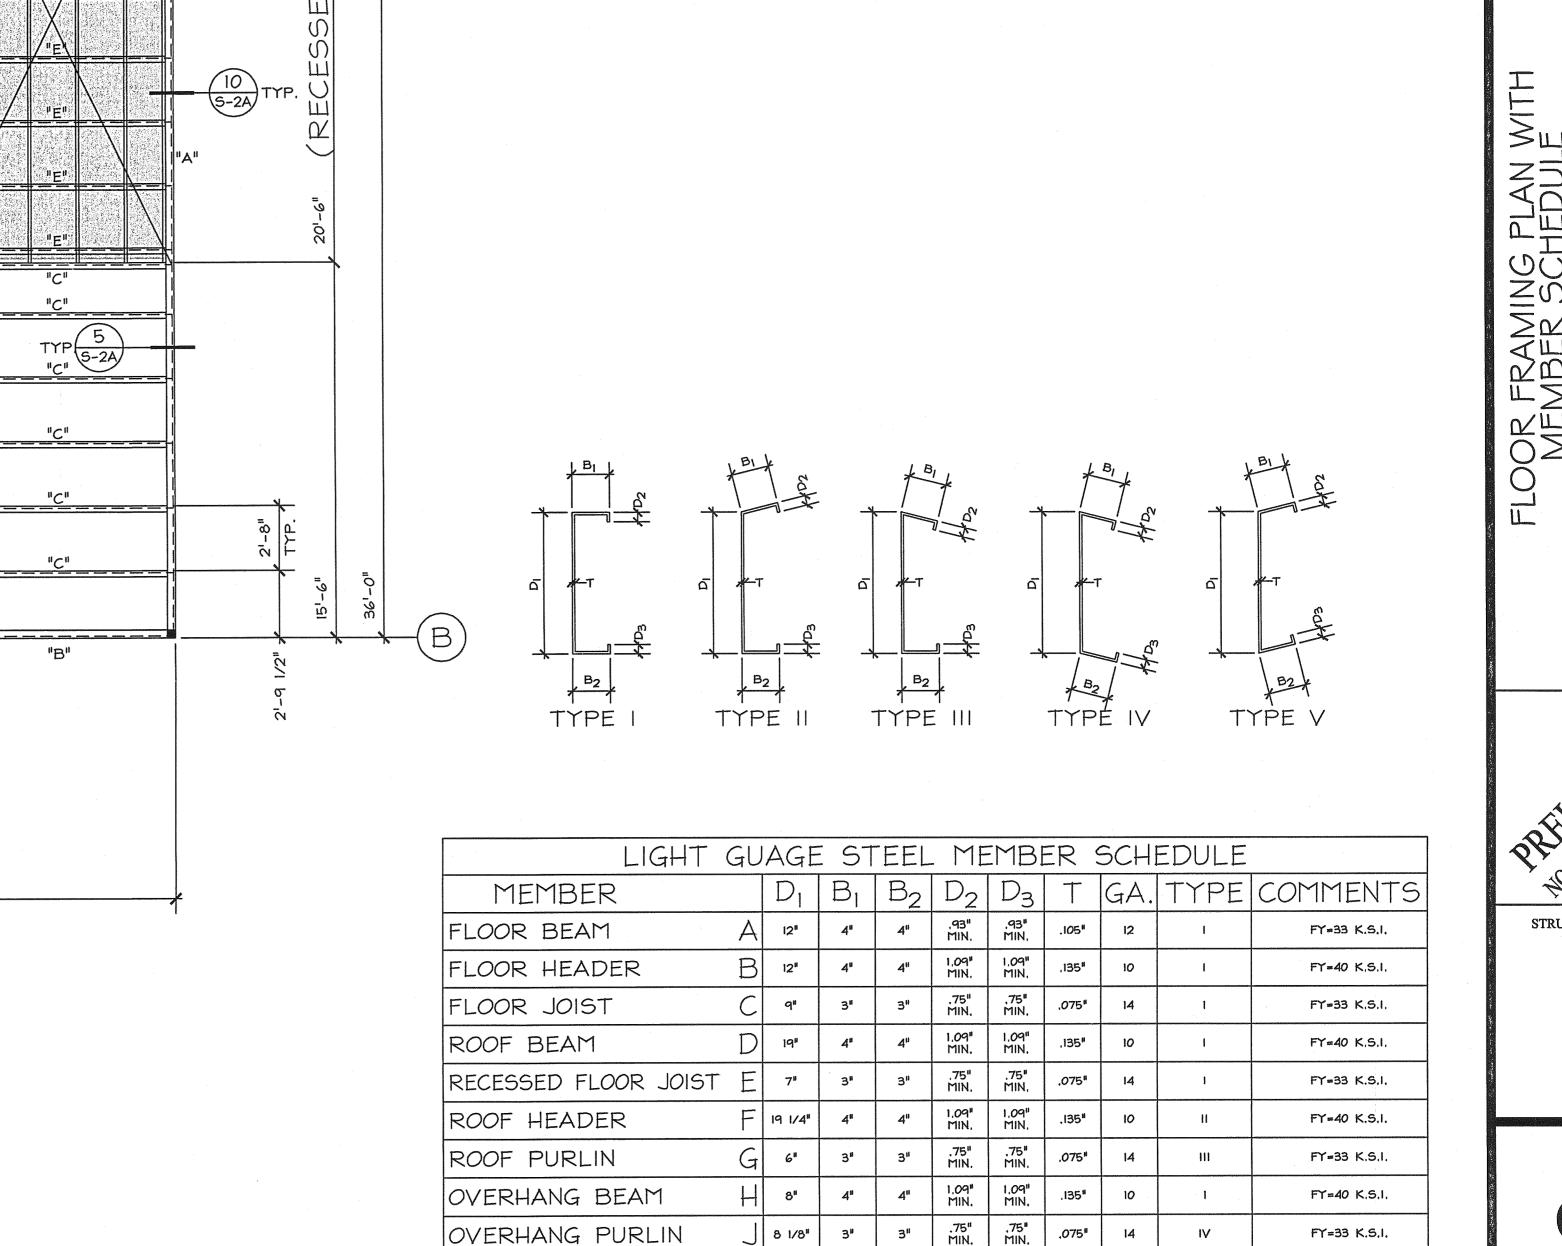


8 1/8"

6 1/16"

3"

3"

.075"

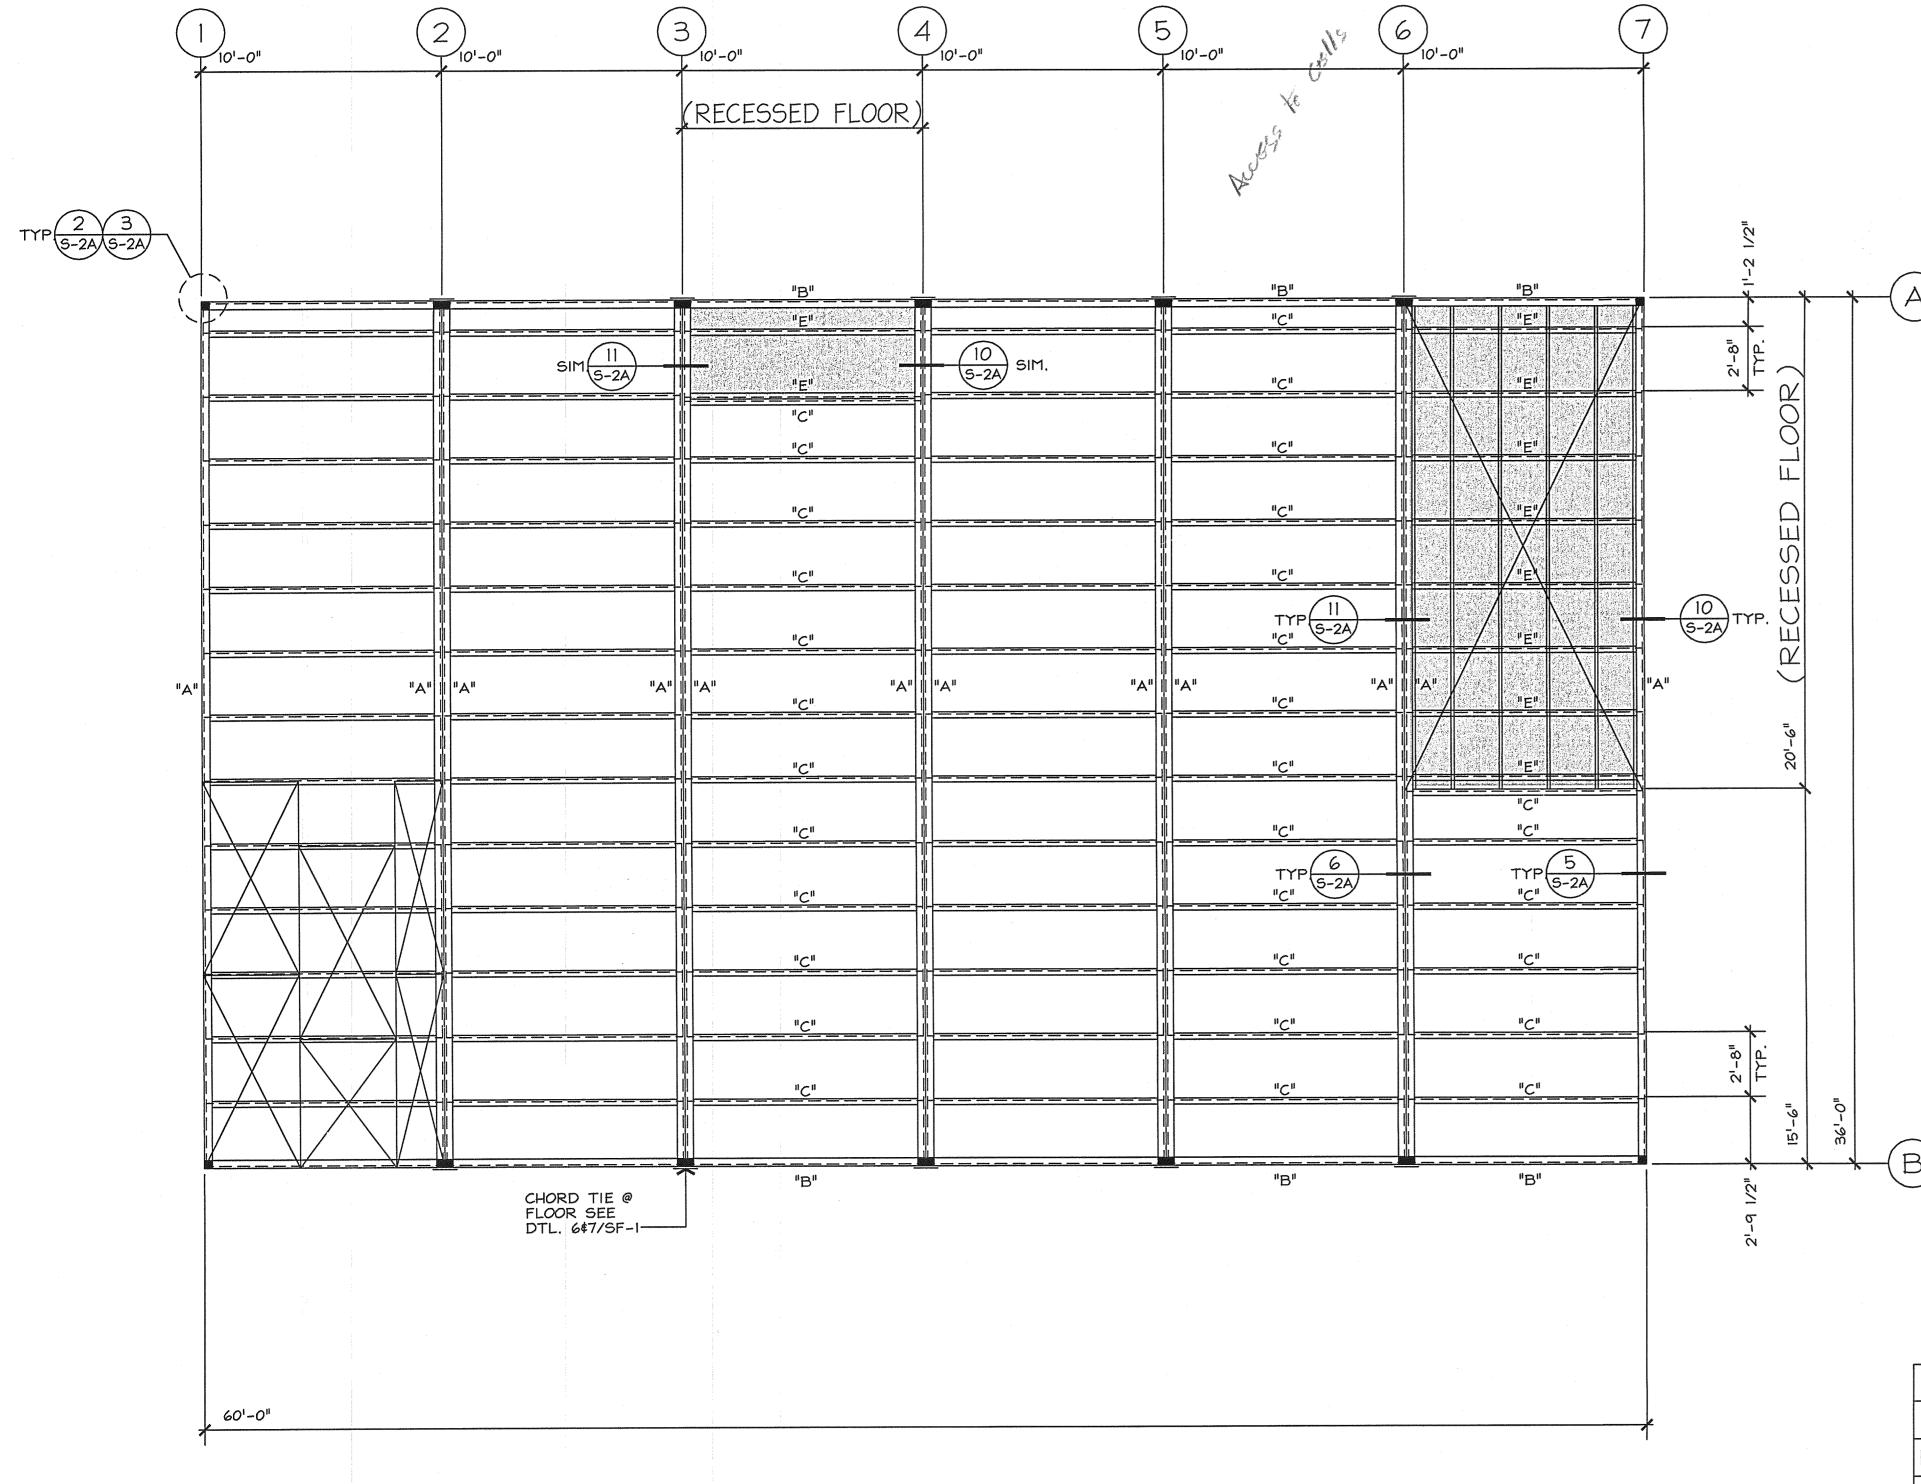

ADDENDUM 1

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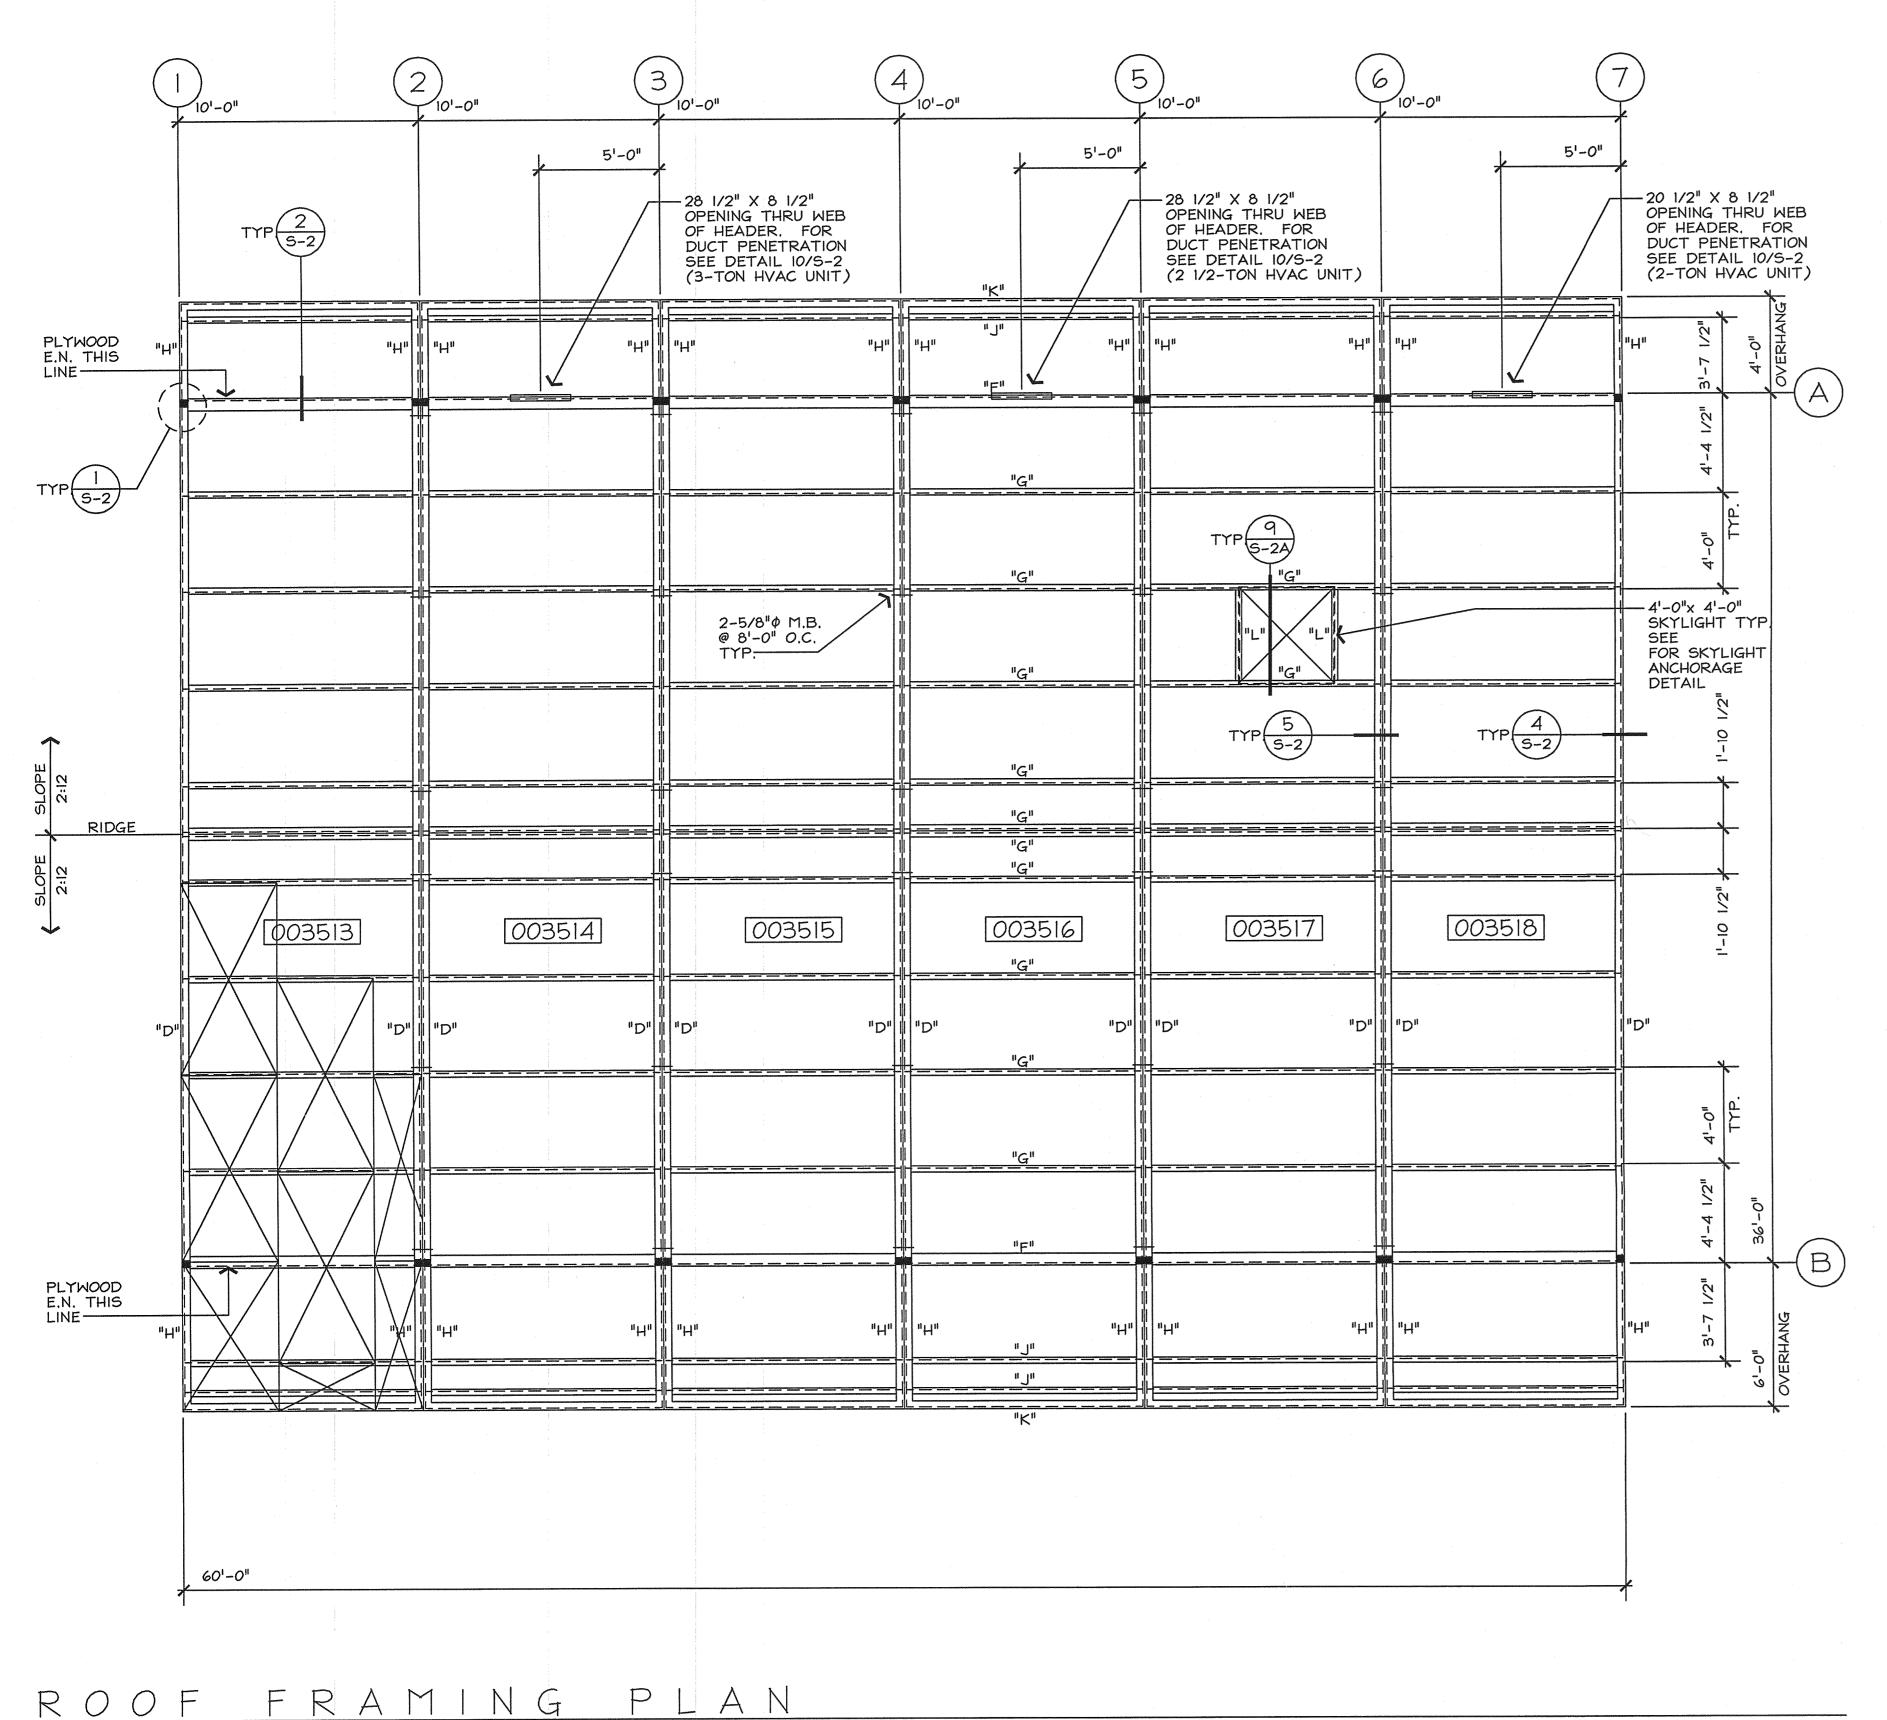
OVERHANG HEADER

MISC. ROOF PURLIN

OF SHEETS


FY=40 K.S.I.

FY=33 K.S.I.




NOTES:

- 1. 3/4" OR 23/32 CDX. UNDERLAYMENT 48/24 OR 24" O.C. SPAN RATING PER PS-1-83 W/ T&G EDGES EXPOSURE 1 P.T.S. APA OR TECO W/#10 x 1 1/2" F.H. SELF TAP SCREWS @ 6" O.C. F.N. & 6" O.C. F.N.
- 2. AS AN ALTERNATE TO #10 x 1 1/2"
 F.H. SELF TAP SCREWS @ PLYWOOD
 TO ROOF FRAMES PROVIDE ERICO
 PINS #AKN-144-0175 0.144¢ x 1 3/4"
 LONG TYP. @ SAME SPACING AS PER
 #10 x 1 1/2" SCREWS SEE 1.C.B.O.
 REPORT #4144 DATED DEC. 1,1995.
- 3. AS AN ALTERNATE TO 3/4" OR 23/32" CDX. UNDERLAYMENT(ROOF PLYWOOD) PROVIDE 3/4" OR 23/32" ORIENTED STRAND BOARD ROOF SHEATHING TYP. PER PRODUCT ACCEPTANCE NO. PA-062 DATED JUNE 25 1997, PROVIDE LOUISIANA-PACIFIC CORP. APA RATED SHEATHING EXPOSURE 1, ONLY.
- 4. ALL ROOF PURLIN DIMINSIONS ARE MEASURED ALONG THE DIAGONAL SLOPE OF THE ROOF TYP.

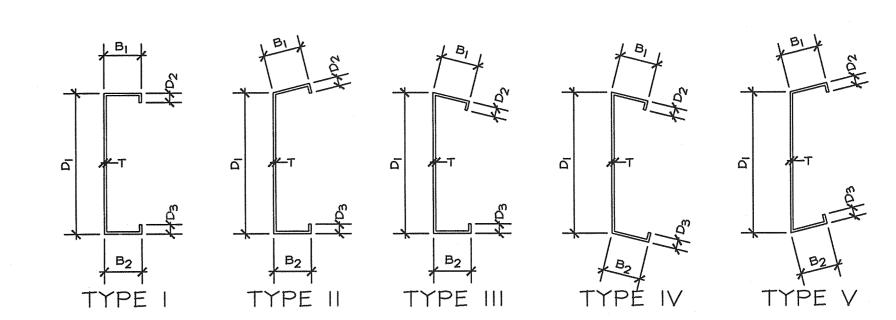

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MEMBER		D_1	B _I	B_2	D_2	D_3		GA.	TYPE	COMMENTS
FLOOR BEAM	A	12"	4"	4"	.93" MIN.	.93" MIN.	.1058	12		FY=33 K.S.I.
FLOOR HEADER	В	12"	- 4"	4"	1.09" MIN.	1.09" MIN.	.135"	10	ı	FY=40 K.S.I.
FLOOR JOIST	C	9 "	3"	3"	,75" MIN.	.75" MIN.	.075"	14	ı	FY=33 K.S.I.
ROOF BEAM	D	19#	4 ⁸	4 ¹¹	1.09" MIN.	1.09# MIN.	.135"	10	l	FY=40 K.S.I.
RECESSED FLOOR JOIST	E	7"	3#	3"	.75" MIN.	.75" MIN,	.075"	14	l	FY=33 K.S.I.
ROOF HEADER	F	19 1/4"	4"	4"	1,09" MIN,	1,09" MIN.	.135"	10	- 11	FY=40 K.S.I.
ROOF PURLIN	G	6"	3"	3"	.75" MIN.	.75" MIN.	.075"	14	`.!!!	FY=33 K.S.I.
OVERHANG BEAM	H	8"	4ª	4"	1.09" MIN.	1,09" MIN.	.135"	10		FY=40 K,5.I.
OVERHANG PURLIN	J	8 1/8 ¹¹	3"	3"	.75" MIN.	.75" MIN.	.075"	14	IV	FY=33 K.S.I.
OVERHANG HEADER	K	8 1/8"	4"	4"	1.09" MIN.	1.09" MIN.	.135"	10	V	FY=40 K.S.I.
MISC. ROOF PURLIN	L	6 1/16"	3"	3"	.75" MIN.	,75" MIN.	,075"	14		FY=33 K.S.I.

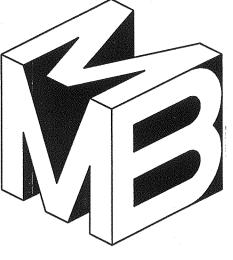



MEEHLEIS MODULAR BUILDINGS, INC. A DESIGN BUILD COMPANY

1303 E. LODI AVE. LODI, CA. 95240 (209) 334-4637 CA. LIC. NO. 473488 NV. LIC. NO. 37887

DATE: JULY 24, 2000 DRAWN: KMC CHECKED: REVISIONS: New Building for: Las Gallinas Valley Sanitary District San Rafael, California San Rafael, California The commerce of the Module Building, the und we not to be reprodued, changed or copied without the cerescal written permission of the Module Module Building, the und we not to be reprodued, changed or copied without the cerescal written permission of the Module Module Building, the und we not to be reprodued, changed or copied without the cerescal written permission of the Module Module Building.
ROOF FRAMING PLAN WITH MEMBER SCHEDULE New Building for: Las Gallinas Valley Sanitary District San Rafael, California These documents are the property of the Meetleis Modular Buildings, fine, and are not to be reproduced, changed or copied without the expressed written permission of the Medial Modular Buildings, fine, and are not to be reproduced, changed or copied without the expressed written permission of the Medial Modular Buildings, fine, and are not to be reproduced, changed or copied without the expressed written permission of the Medial Modular Buildings, fine, and are not to be reproduced, changed or copied without the expressed written permission of the Medial Modular Buildings, fine, and are not to be reproduced, changed or copied without the expressed written permission of the Medial Modular Buildings, fine, and are not to be reproduced, changed or copied without the expressed written permission of the Medial Modular Buildings, fine, and are not to be reproduced, changed or copied without the expressed written permission of the Medial Modular Buildings.
PRILITIAL ENGINEER STRUCTURAL ENGINEER

SCALE 1/4"=1'-0"

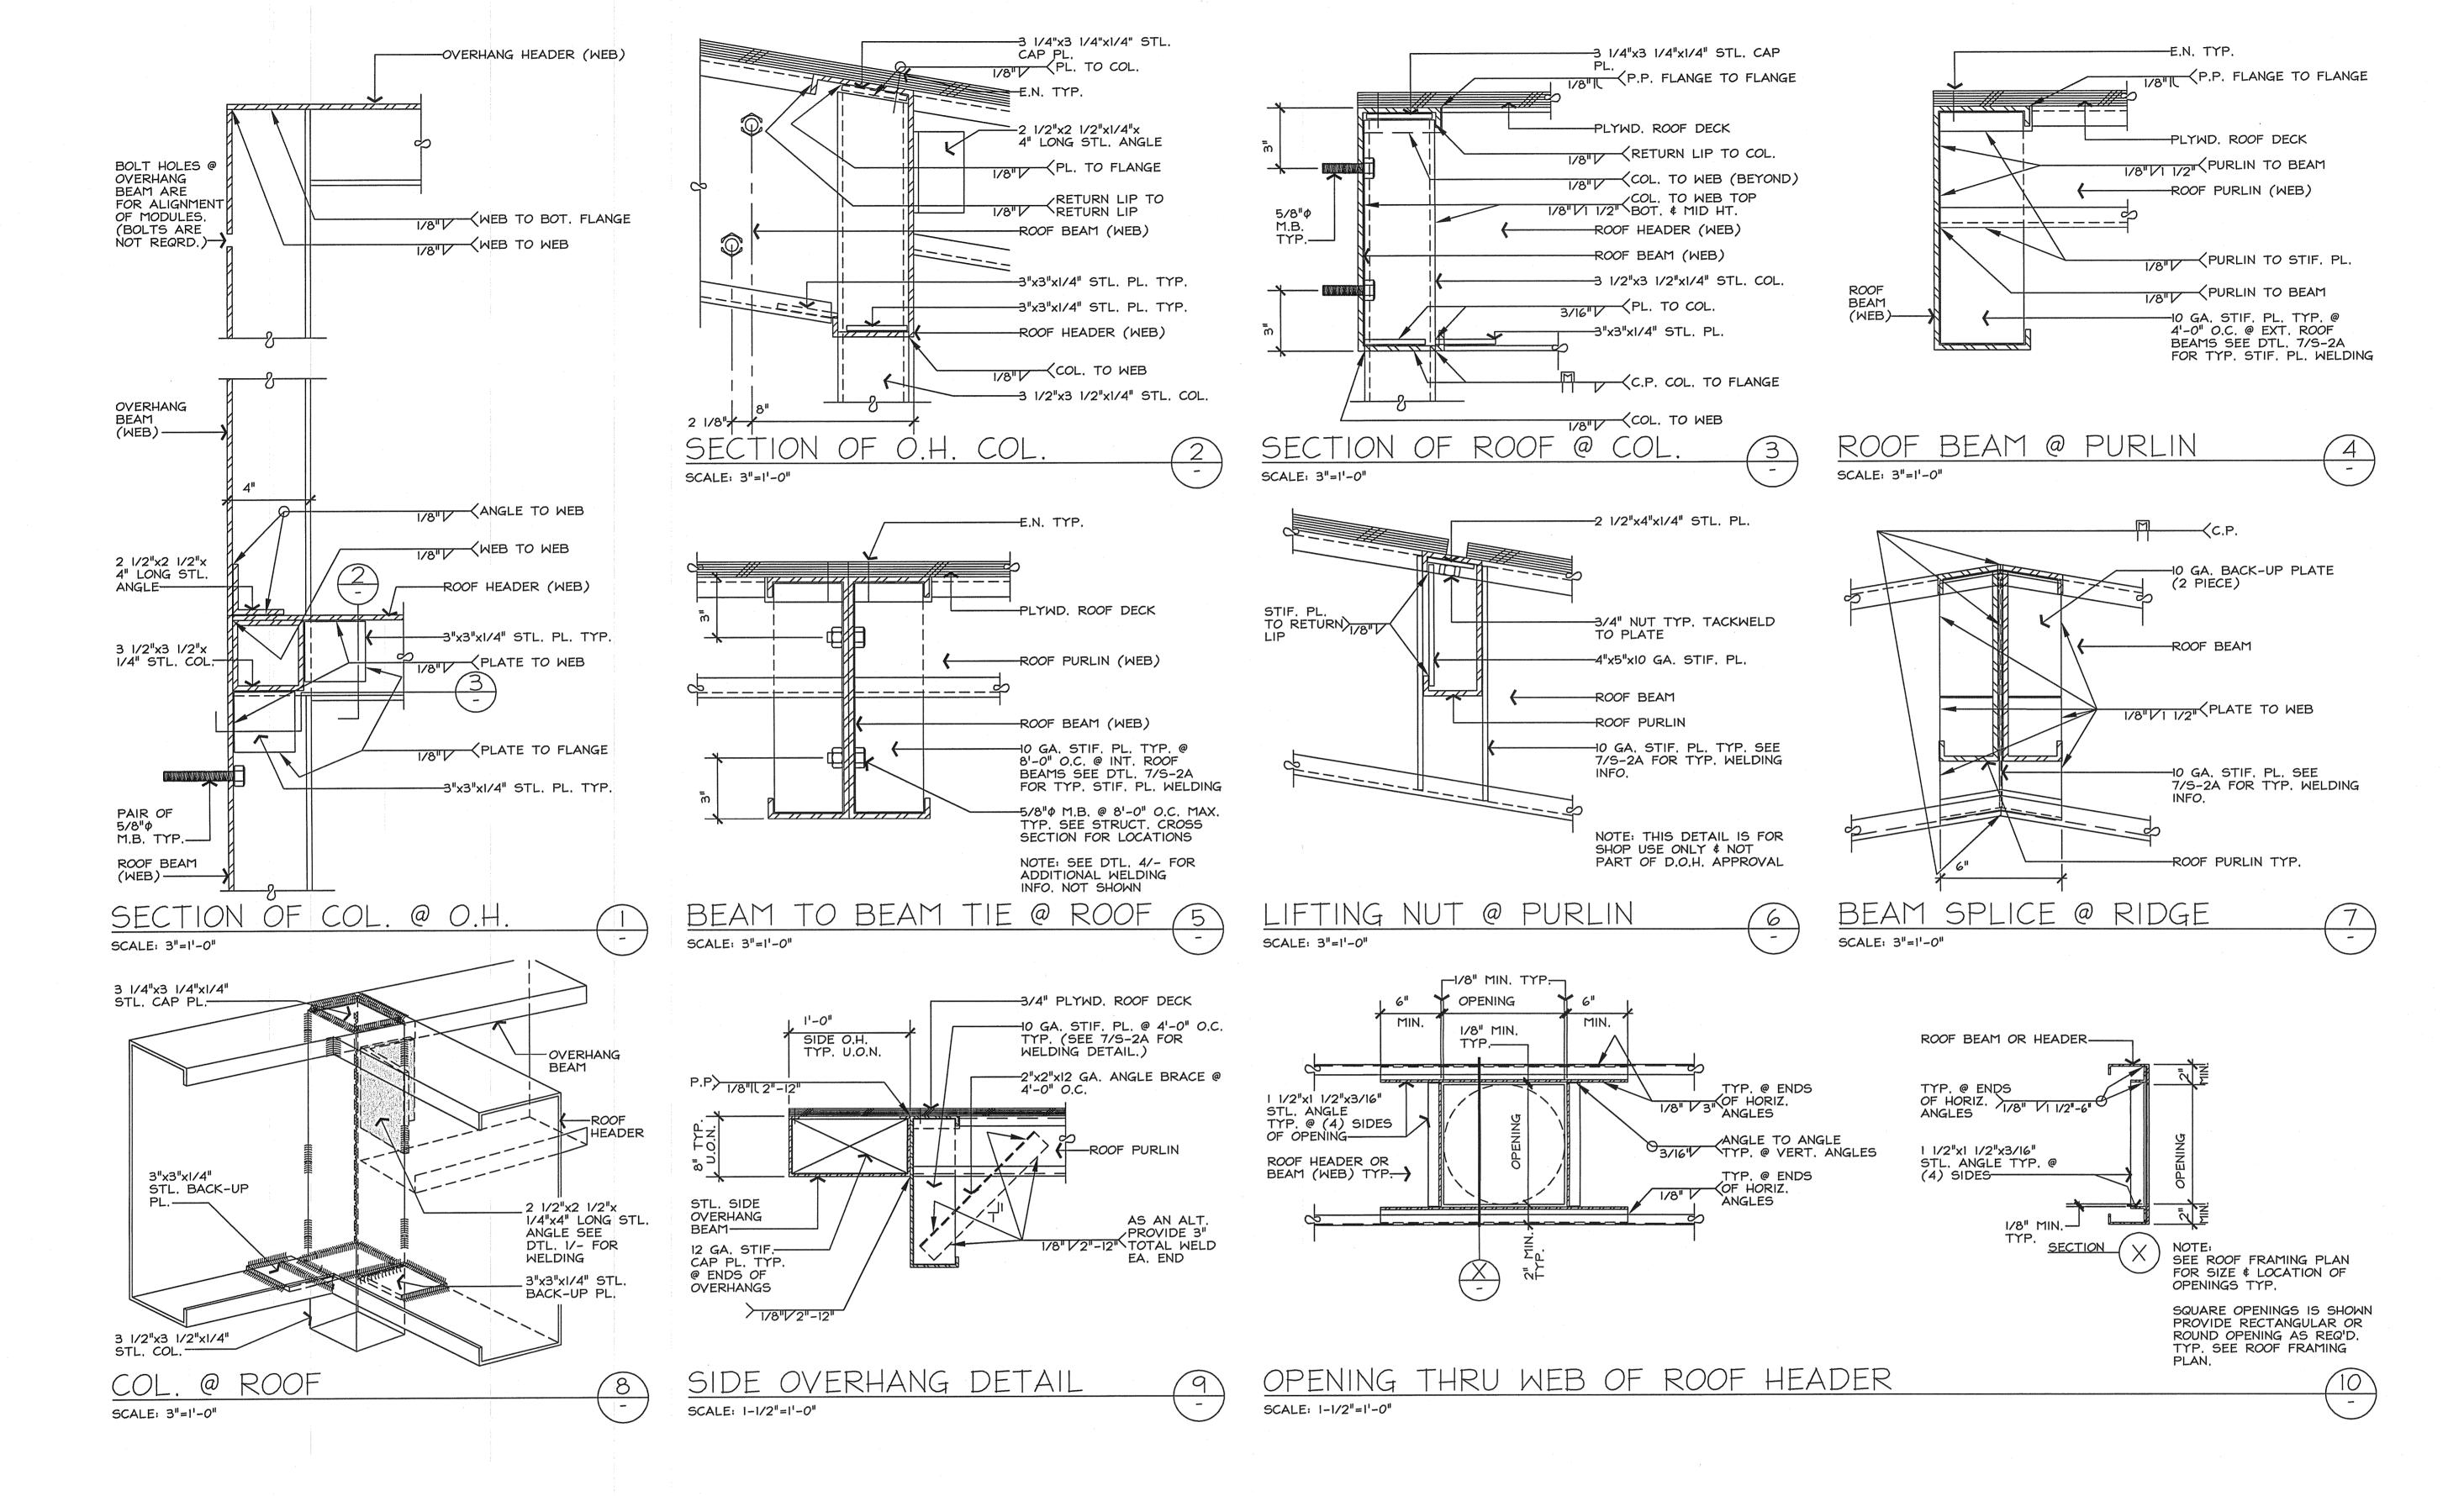

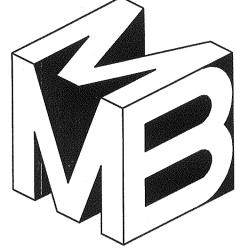



MEEHLEIS MODULAR BUILDINGS, INC. A DESIGN BUILD COMPANY


1303 E. LODI AVE. LODI, CA. 95240 (209) 334-4637 CA. LIC. NO. 473488 NV. LIC. NO. 37887

SI	STRUCTURAL STEEL DETAILS AT ROOF	DRAWN: CHECKED: REVISIONS:	DATE:
HEET NO.	New Building for: Las Gallinas Valley Sanitary District San Rafael, California	BLB .	JUNE 12, 2000
00415	These documents are the property of the Meehleis Modular Buildings, Inc. and are not to be reproduced, changed or copied written permission of the Modular Manufacturer.	100 mg	

SHEETS

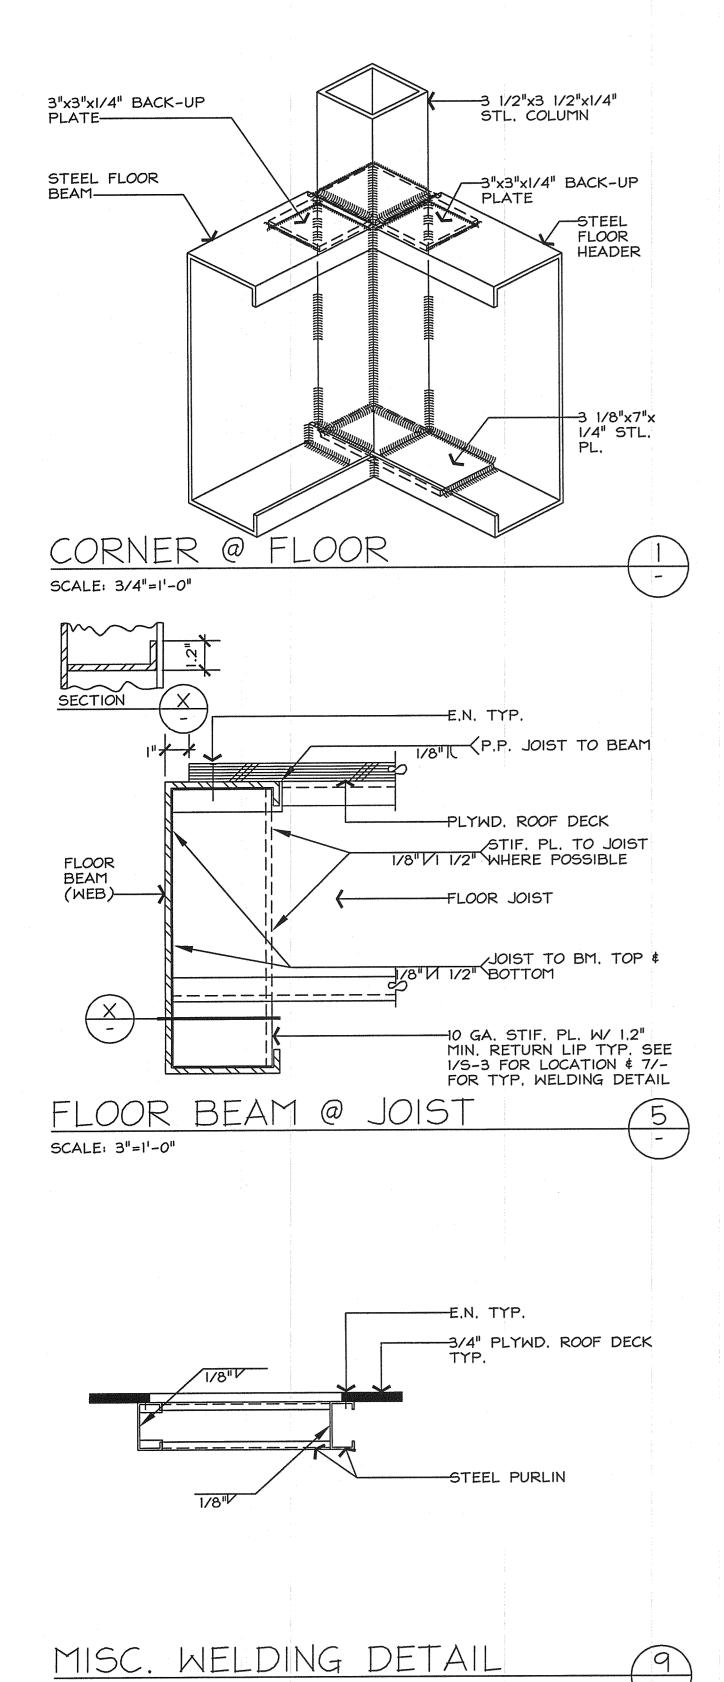

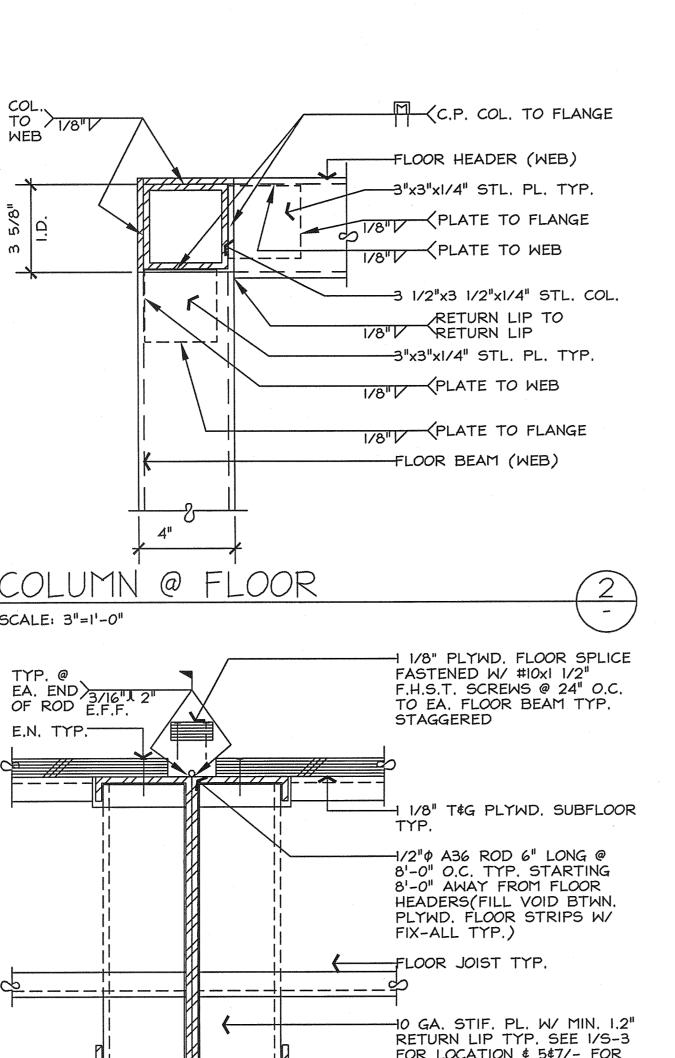

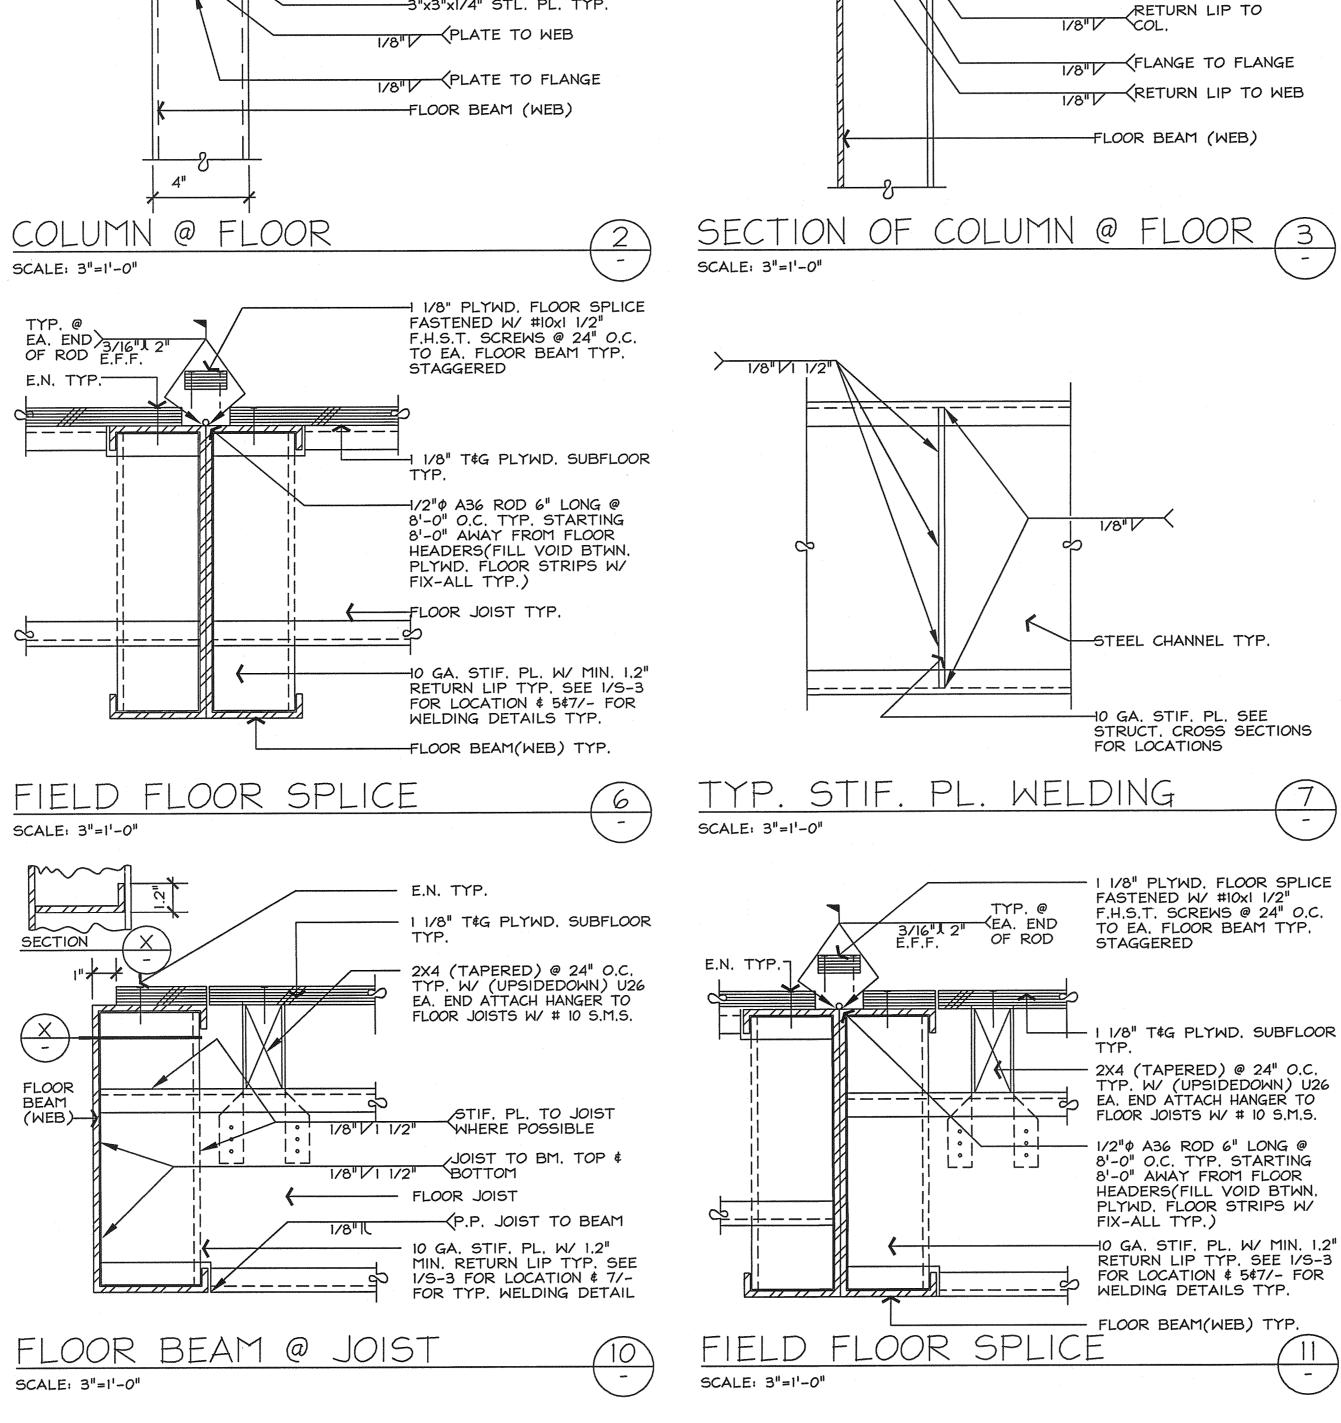

WEB TO 1/8"/V

PLATE TO COL.


-ROOF HEADER (WEB)


PLATE TO FLANGE


-3 1/8"x7"x1/4" STL. PL.

RETURN LIP TO RETURN LIP

-3 1/2"x3 1/2"x1/4" STL. COL.

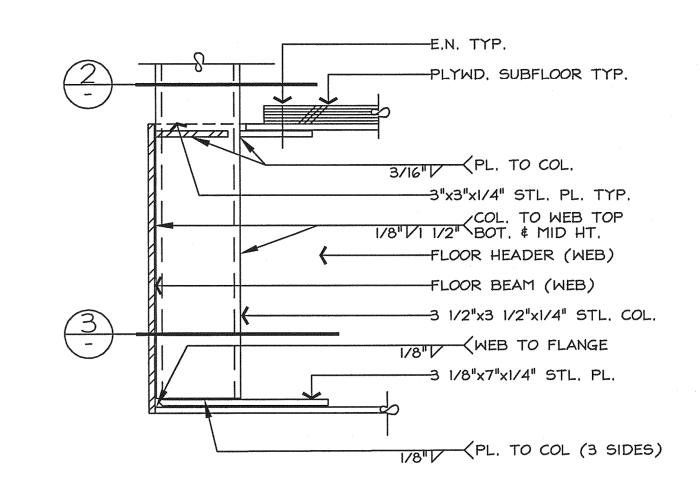

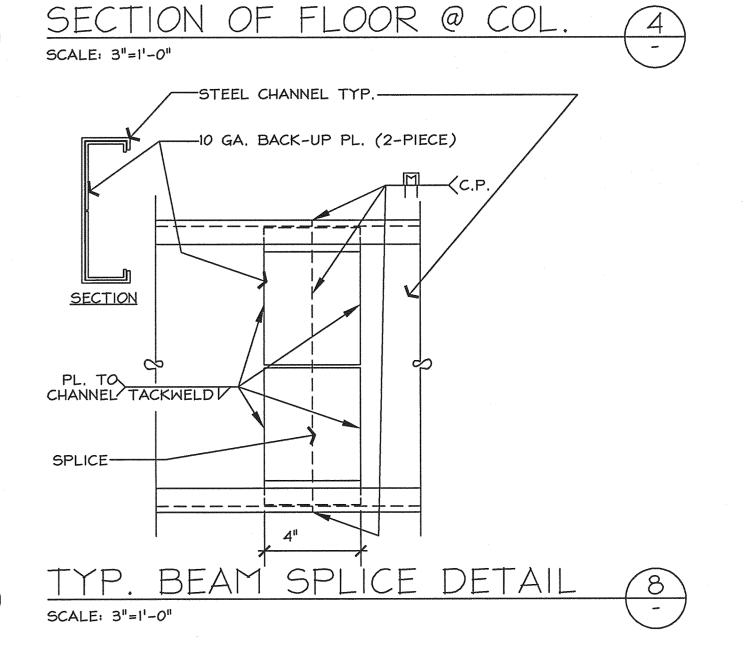

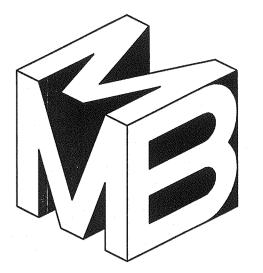


MEEHLEIS MODULAR BUILDINGS, INC. A DESIGN BUILD COMPANY


1303 E. LODI AVE. LODI, CA. 95240 (209) 334-4637 CA. LIC. NO. 473488 NV. LIC. NO. 37887

DATE: DRAWN: CHECKED: REVISIONS:	alley Sanitary District	or copied without the expressed written permission of the Modular Manufacturer.
STRUCTURAL STEEL DE AT FLOOR	New Building for: Las Gallinas Valley Sa San Rafael, California	These documents are the property of the Meehleis Modular Buildings, Inc. and are not to be reproduced, changed or copied without the expr
STRUCT	TURAL ENGINEER	
SH	EET NO.	NO.: 00415

07/24/2000 : \PROJECT FILES\LAS GALLINAS\Plt Files\S-1.plt,.09: 17: 57

SCALE: 1"=1'-0"

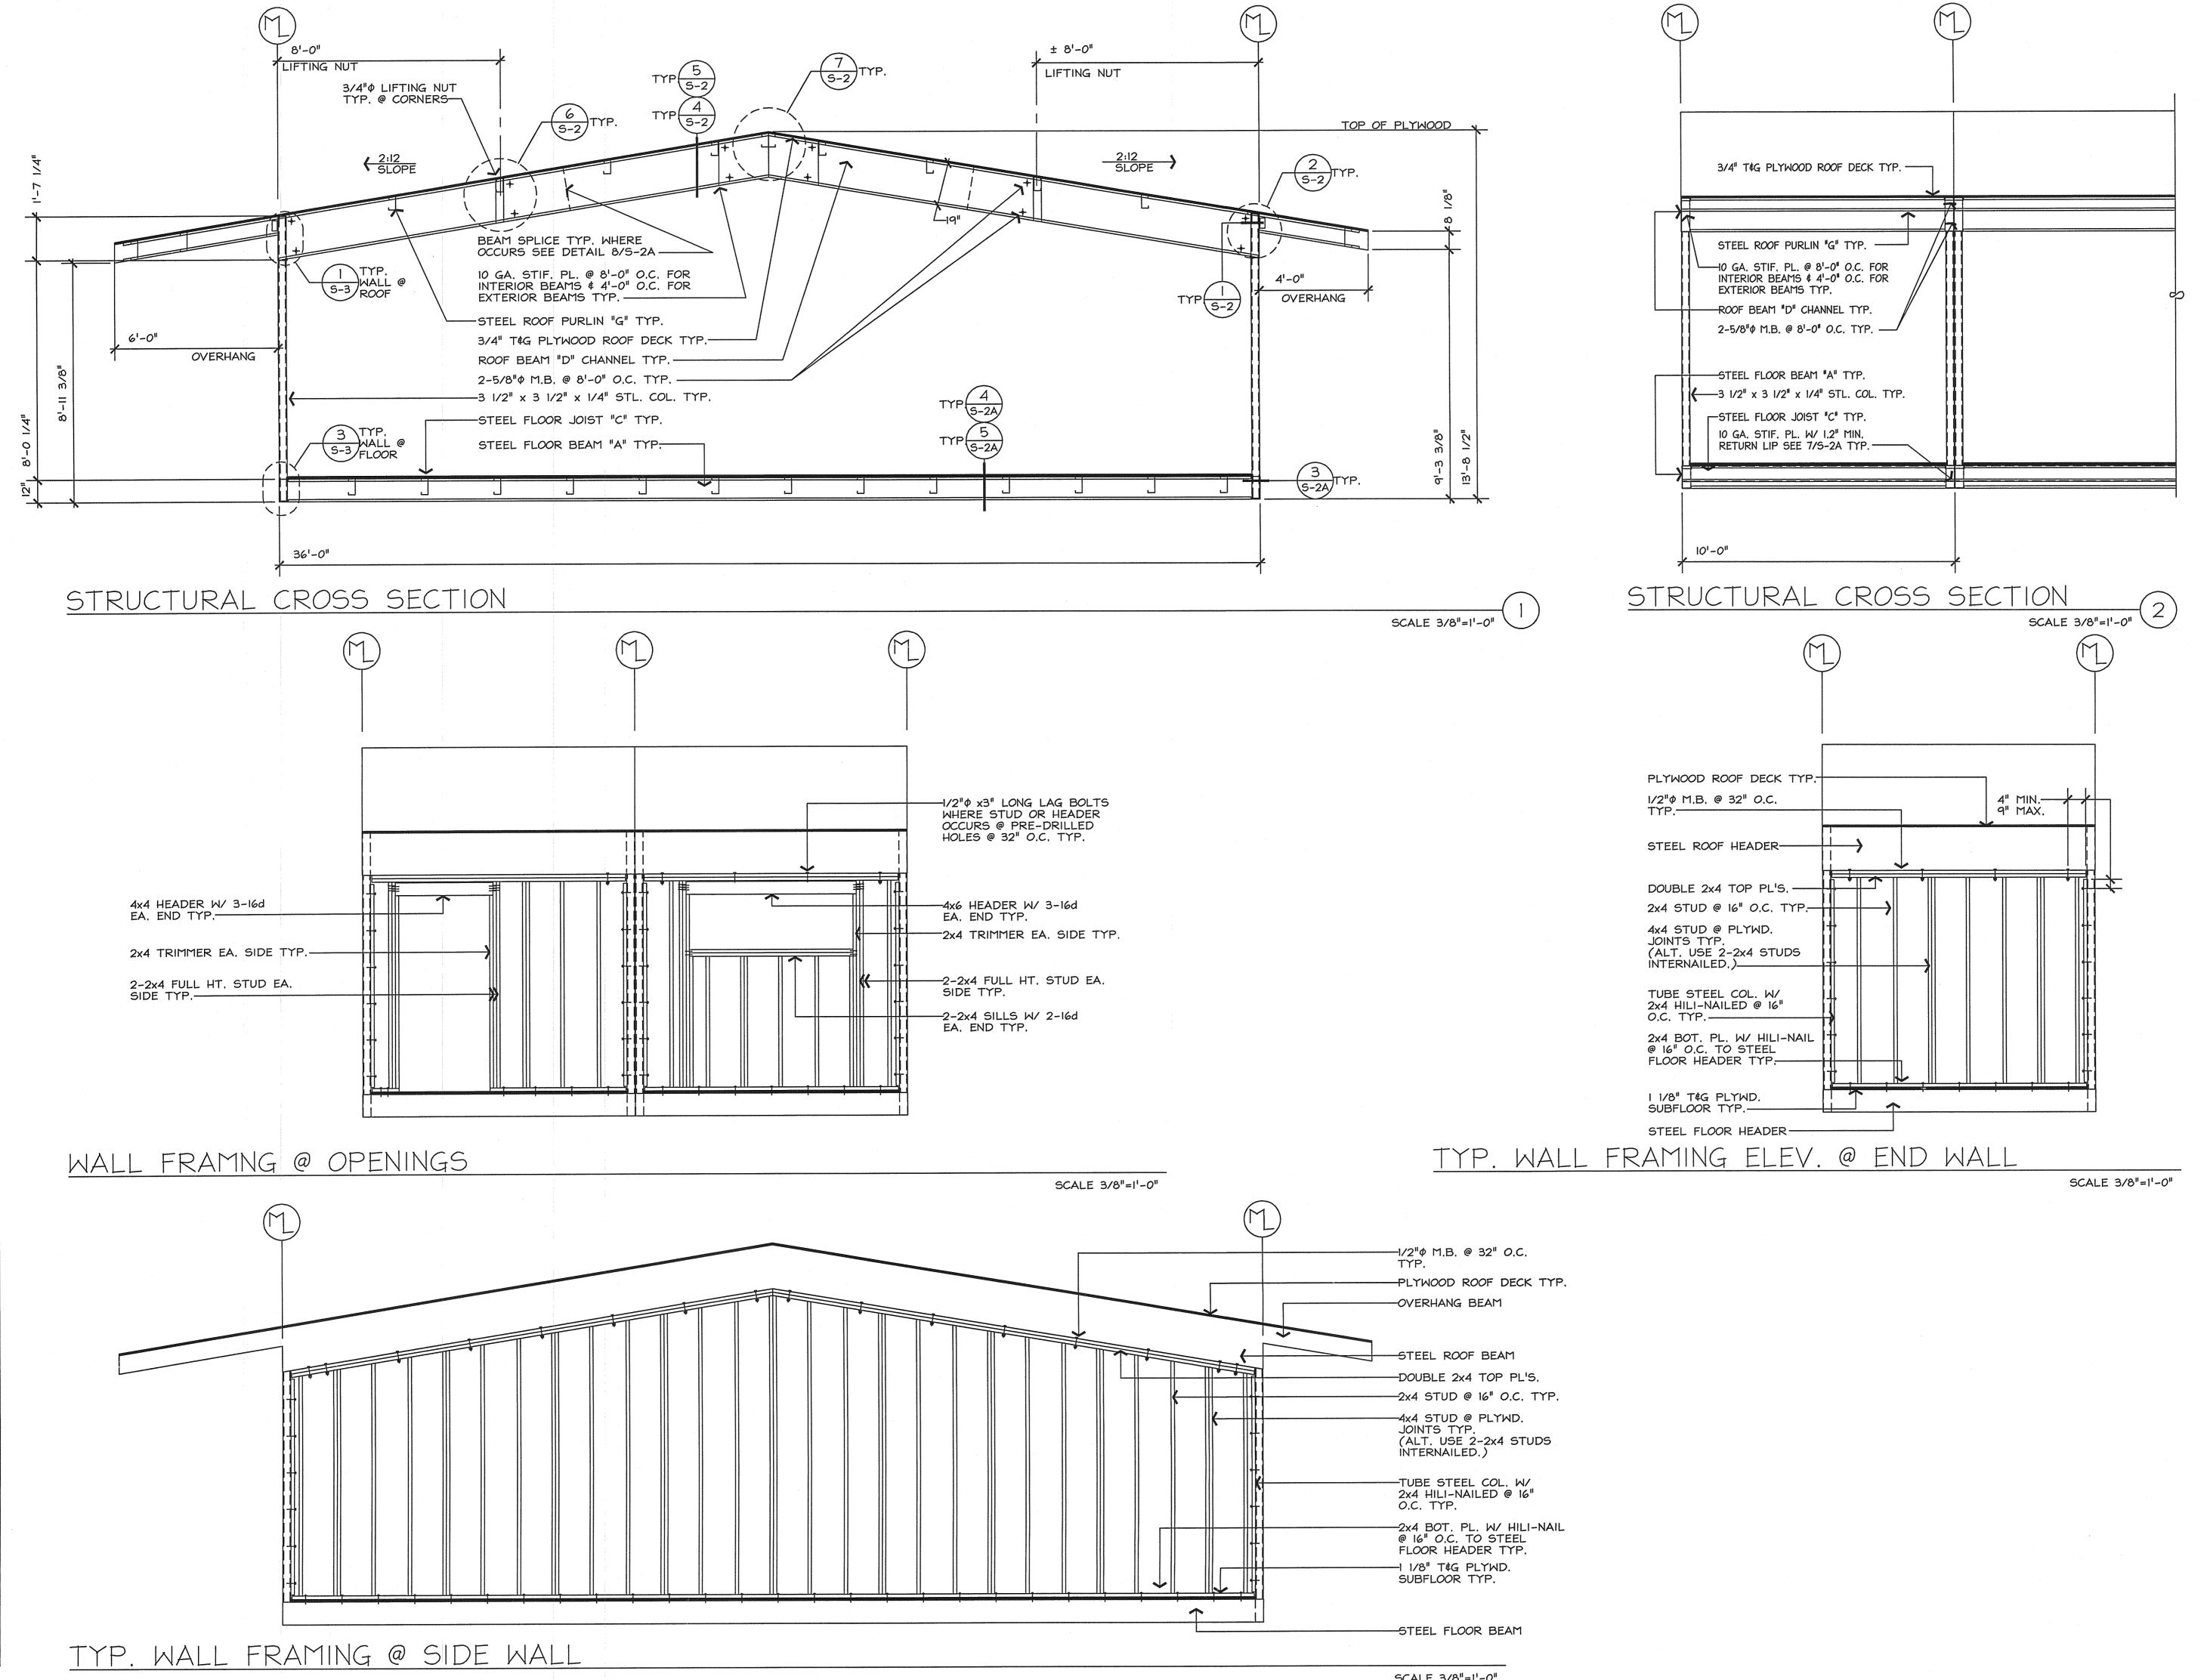


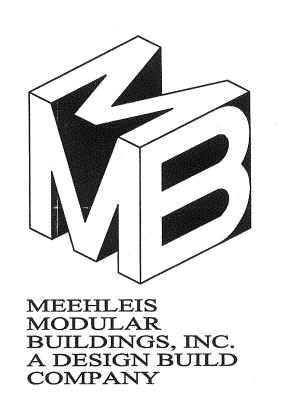

1303 E. LODI AVE. LODI, CA. 95240 (209) 334-4637 CA. LIC. NO. 473488 NV. LIC. NO. 37887

SH	}	STRUCTURAL CROSS-SECTIONS WITH TYP. WALL FRAMING ELEVATION	DATE: DRAWN: CHECKED: REVISIONS:
EET NO.	TURAL ENGINEER	New Building for: Las Gallinas Valley Sanitary District	JULY 24, 2000 KMC
00415		These documents are the property of the Meehleis Modular Buildings, Inc. and are not to be reproduced, changed or copied without the expressed written permission of the Modular Manufacturer.	

SHEETS

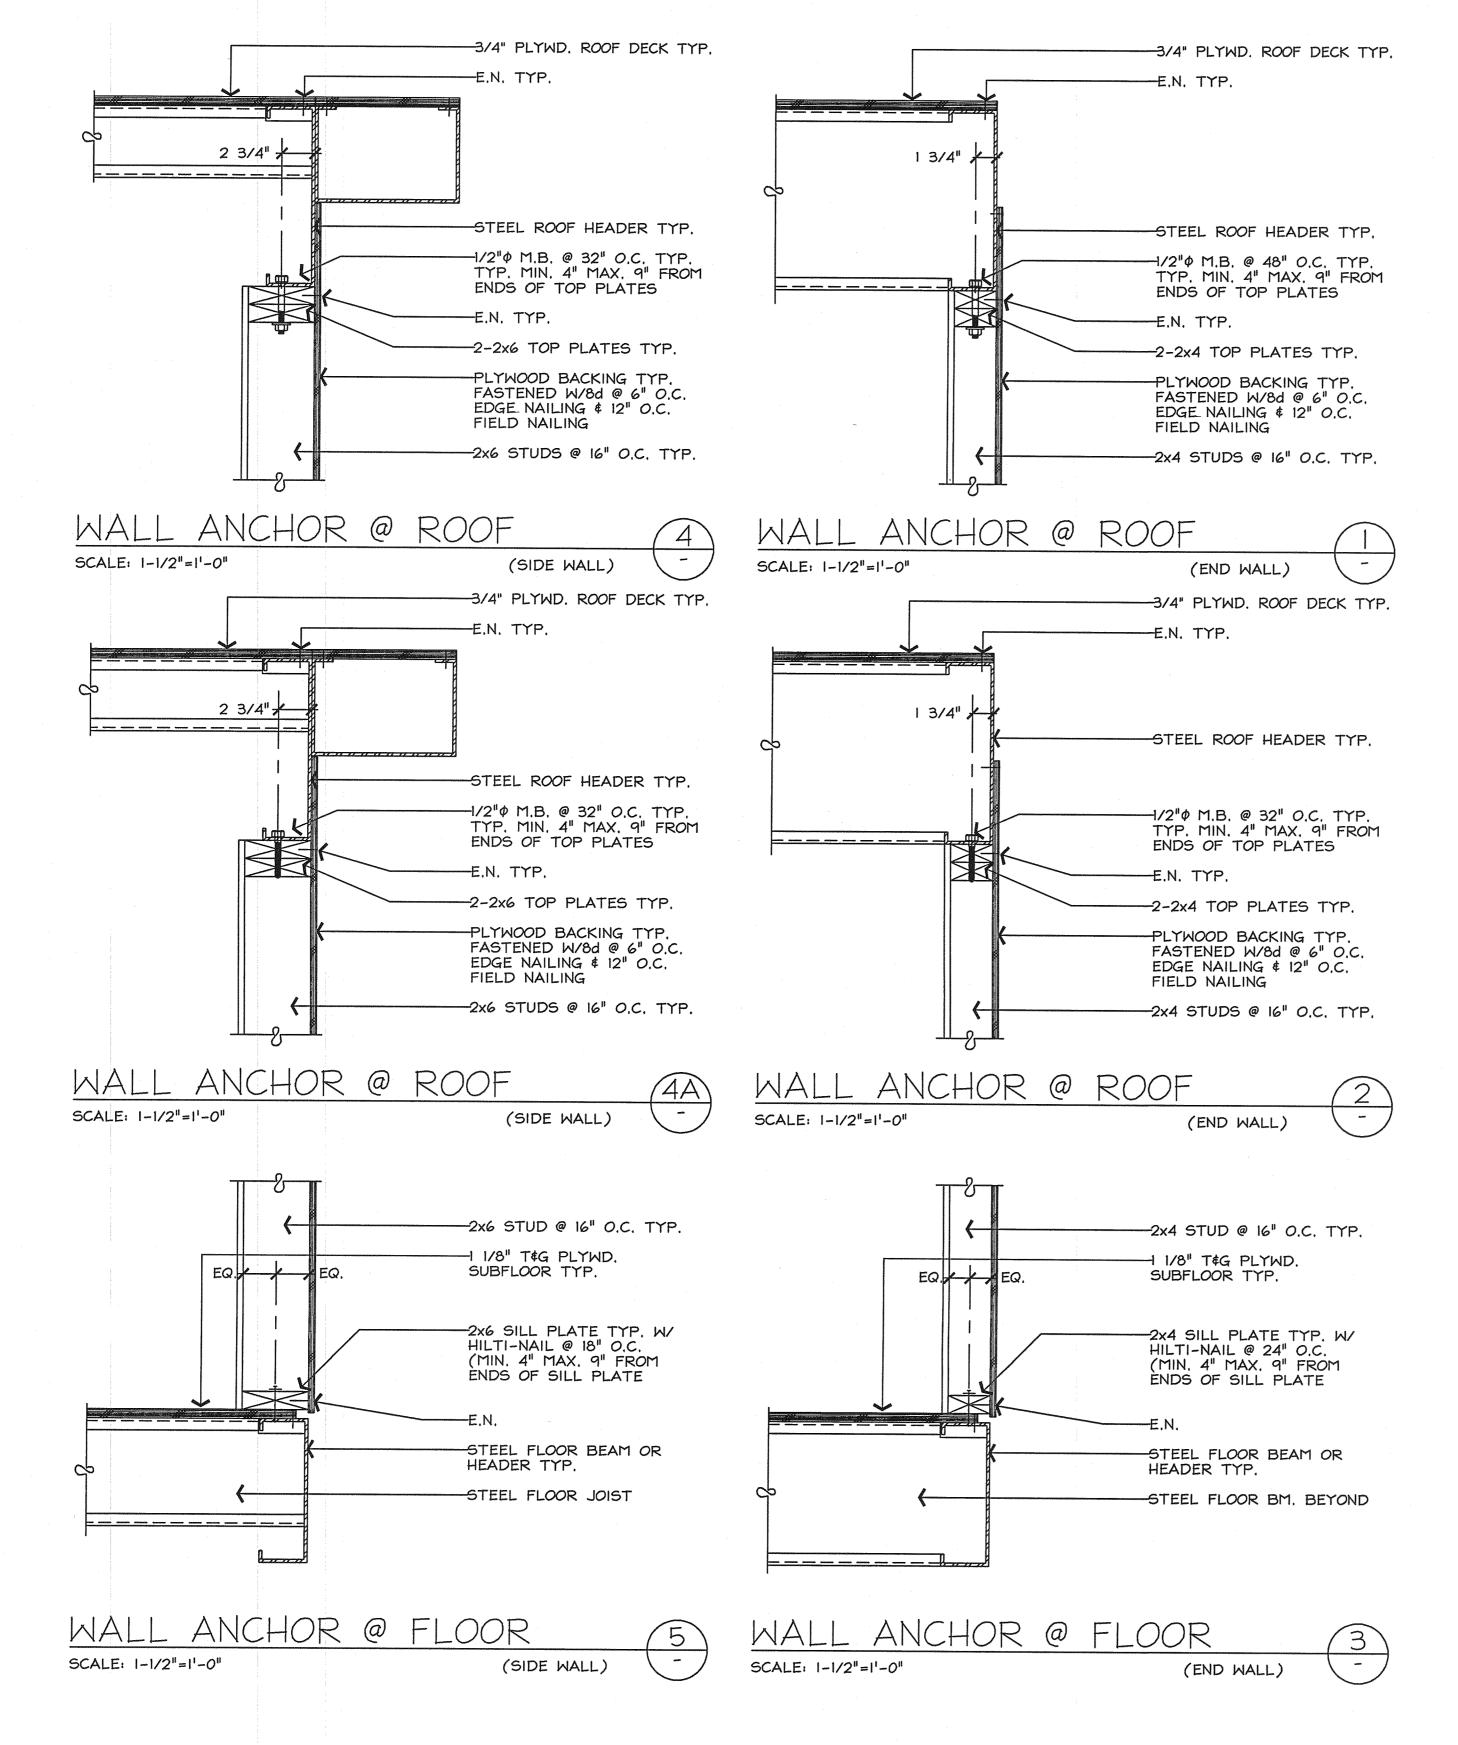

STRUCTURAL NOTES:

GENERAL: DETAILS & NOTES SHOWN ARE TYPICAL \$ SHALL APPLY UNLESS OTHERWISE SHOWN OR NOTED DETAILS OF CONSTRUCTION NOT FULLY SHOWN SHALL BE OF SAME NATURE AS SHOWN FOR SIMILAR CONSTRUCTION,

A. FABRICATION & WORKMANSHIP SHALL CONFORM TO U.B.C. CHAPTER 22, DIVISIONS I III Y & VII.

- STRUCTURAL STEEL SHALL CONFORM TO THE A.S.T.M. A-36, STEEL TUBING SHALL CONFORM TO THE A.S.T.M. A-500 GRADE B.
- C. LIGHT GAGE STEEL SHALL CONFORM TO THE A.S.T.M. A-570 GRADE 33 \$ 40. ELEMENTS SHALL NOT DEVIATE MORE THAN 5% FROM NOMINAL U.S. GAGE (10 GA.-0.1345", 12 GA. - 0.105", \$ 14 GAGE 0.075") SEE PROPERTY
- D. MATERIAL TEST OF BEAMS, PURLINS, TUBE COLUMNS, MISC. ANGLES \$ PLATES SHALL BE TESTED IN ACCORDANCE WITH SECTION 2203, U.B.C. 1997
- **WELDING:** STRUCTURAL WELDING SHALL BE BY THE "ELECTRIC ARC PROCESS" PER A.W.S. DI.I & DI.3 "STRUCTURAL WELDING CODE-STEEL", AND SHALL BE PREFORMED BY "APPROVED WELDERS" IN THE SHOP OF A LICENSED FABRICATOR. WELDING ELECTRODES SHALL BE E70XX FOR STRUCTURAL STEEL & E60XX FOR LIGHT GAGE STEEL TYP.

COMMON BOLTS SHALL CONFORM TO A.S.T.M A-307. RETIGHTEN ALL BOLTS BEFORE CLOSING WALL IN.

LUMBER:

- A. FRAMING; ALL FRAMING SHALL BE GRADE MARKED BY AN APPROVED GRADING AGENCY \$ SHALL CONSIST OF DOUGLAS FIR #2 OR BETTER TYP. FOR HEADERS, STUDS, SILLS, PLATES, BLOCKING ETC.
- B. PLYWOOD; ALL PANELS SHALL BE GRADE MARKED & SHALL BEAR "APA" TRADEMARK LEGIBLY APPLIED. ALL PLYWOOD SHALL BE GRADE MARKED IN ACCORDANCE W/ PSI-95. ALL STRUCTURAL PLYWOOD SHALL HAVE AN EXPOSED I RATING.
- C. WOOD FOUNDATIONS (IF REQUIRED);

NOT USED D. UNLESS OTHERWISE SPECIFIED, ALL LUMBER HANGERS TO BE SIMPSON. NAILING: NAILING TO BE AS PER TABLE 23-II-B-I U.B.C. 1997 TABLE 23-II-B-I TITLE 24 NAILING SCHEDULE AND U.B.C. 1997. JOIST TO SILL OR GIRDER TOENAIL ---BRIDGING TO JOISTS, TOENAIL EA. END ----BLOCKING BETWEEN JOISTS OR RAFTERS TO JOISTS OR RAFTER TOENAIL EA. SIDE, EA. END. -BLOCKING BETWEEN STUDS, EA. END -2-10d TOENAILS OR 2-16d 1x6 SUBFLOOR OR LESS TO EA. JOIST, FACE NAIL -2-8d WIDER THAN IX6 SUBFLOOR OR LESS TO EA. JOIST, FACE NAIL -3-8d 2" SUBFLOOR TO JOIST OR GIRDER, BLIND \$ FACE NAIL -2-16d TOP PLATES, LAP \$ INTERSECTIONS, FACE NAIL -2-16d CONTINUOUS HEADER TO STUD, TOENAIL -4-8d CEILING JOISTS, LAPS OVER PARTITIONS, FACE NAIL -3-16d CEILING JOISTS TO PARALLEL RAFTERS, FACE NAIL -3-16d I" BRACE TO EA. STUD & PLATE, FACE NAIL ----2-8d

LAG BOLTS:
A. THE LEAD HOLE FOR THE SHANK SHALL HAVE THE SAME DIAMETER \$ DEPTH AS THE UNTHREADED SHANK.

B. THE LEAD HOLE FOR THE THREADED PORTION SHALL HAVE A DIAMETER EQUAL TO 60% OF THE SHANK AND LENGTH AT LEAST EQUAL TO THE THREADED PORTION.

1x8 SHEATING OR LESS TO EA. BEARING, FACE NAIL -2-8d


WIDER THAN IX8 SHEATHING TO EA. BEARING, FACE NAIL -3-8d

2-16d @ EA. BEARING

- C. THE BOLT SHALL BE INSERTED BY TURNING WITH A WRENCH, NOT BY DRIVING WITH A HAMMER. SOAP OR OTHER LUBRICANT SHALL BE USED.
- D. RETIGHTEN ALL BOTLS BEFORE CLOSING WALLS IN.


2" PLANKS -----


- BUILDING CODES: ALL CONSTRUCTION AND WORKMANSHIP SHALL CONFORM TO THE U.B.C. 1997 EDITION. A COPY OF THE ABOVE MENTIONED CODES SHALL BE MADE AVAILABLE AT THE PLANT AND SITE.
- HILTI-NAILS:
 UNLESS OTHERWISE NOTED ALL HILTI-NAILS USED SHALL BE CATALOG# X-ZP72P8S36 SHANK DIAMETER 0.145" PER I,C,B,O, REPORT #2388 DATED NOVEMBER 1, 1995

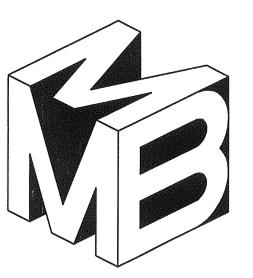

MEEHLEIS MODULAR BUILDINGS, INC. A DESIGN BUILD COMPANY

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-8d @ 6" O.C. E.N. \$ 8d @ 12" O.C. F.N.			
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SCALE 1/4"=1'-0"

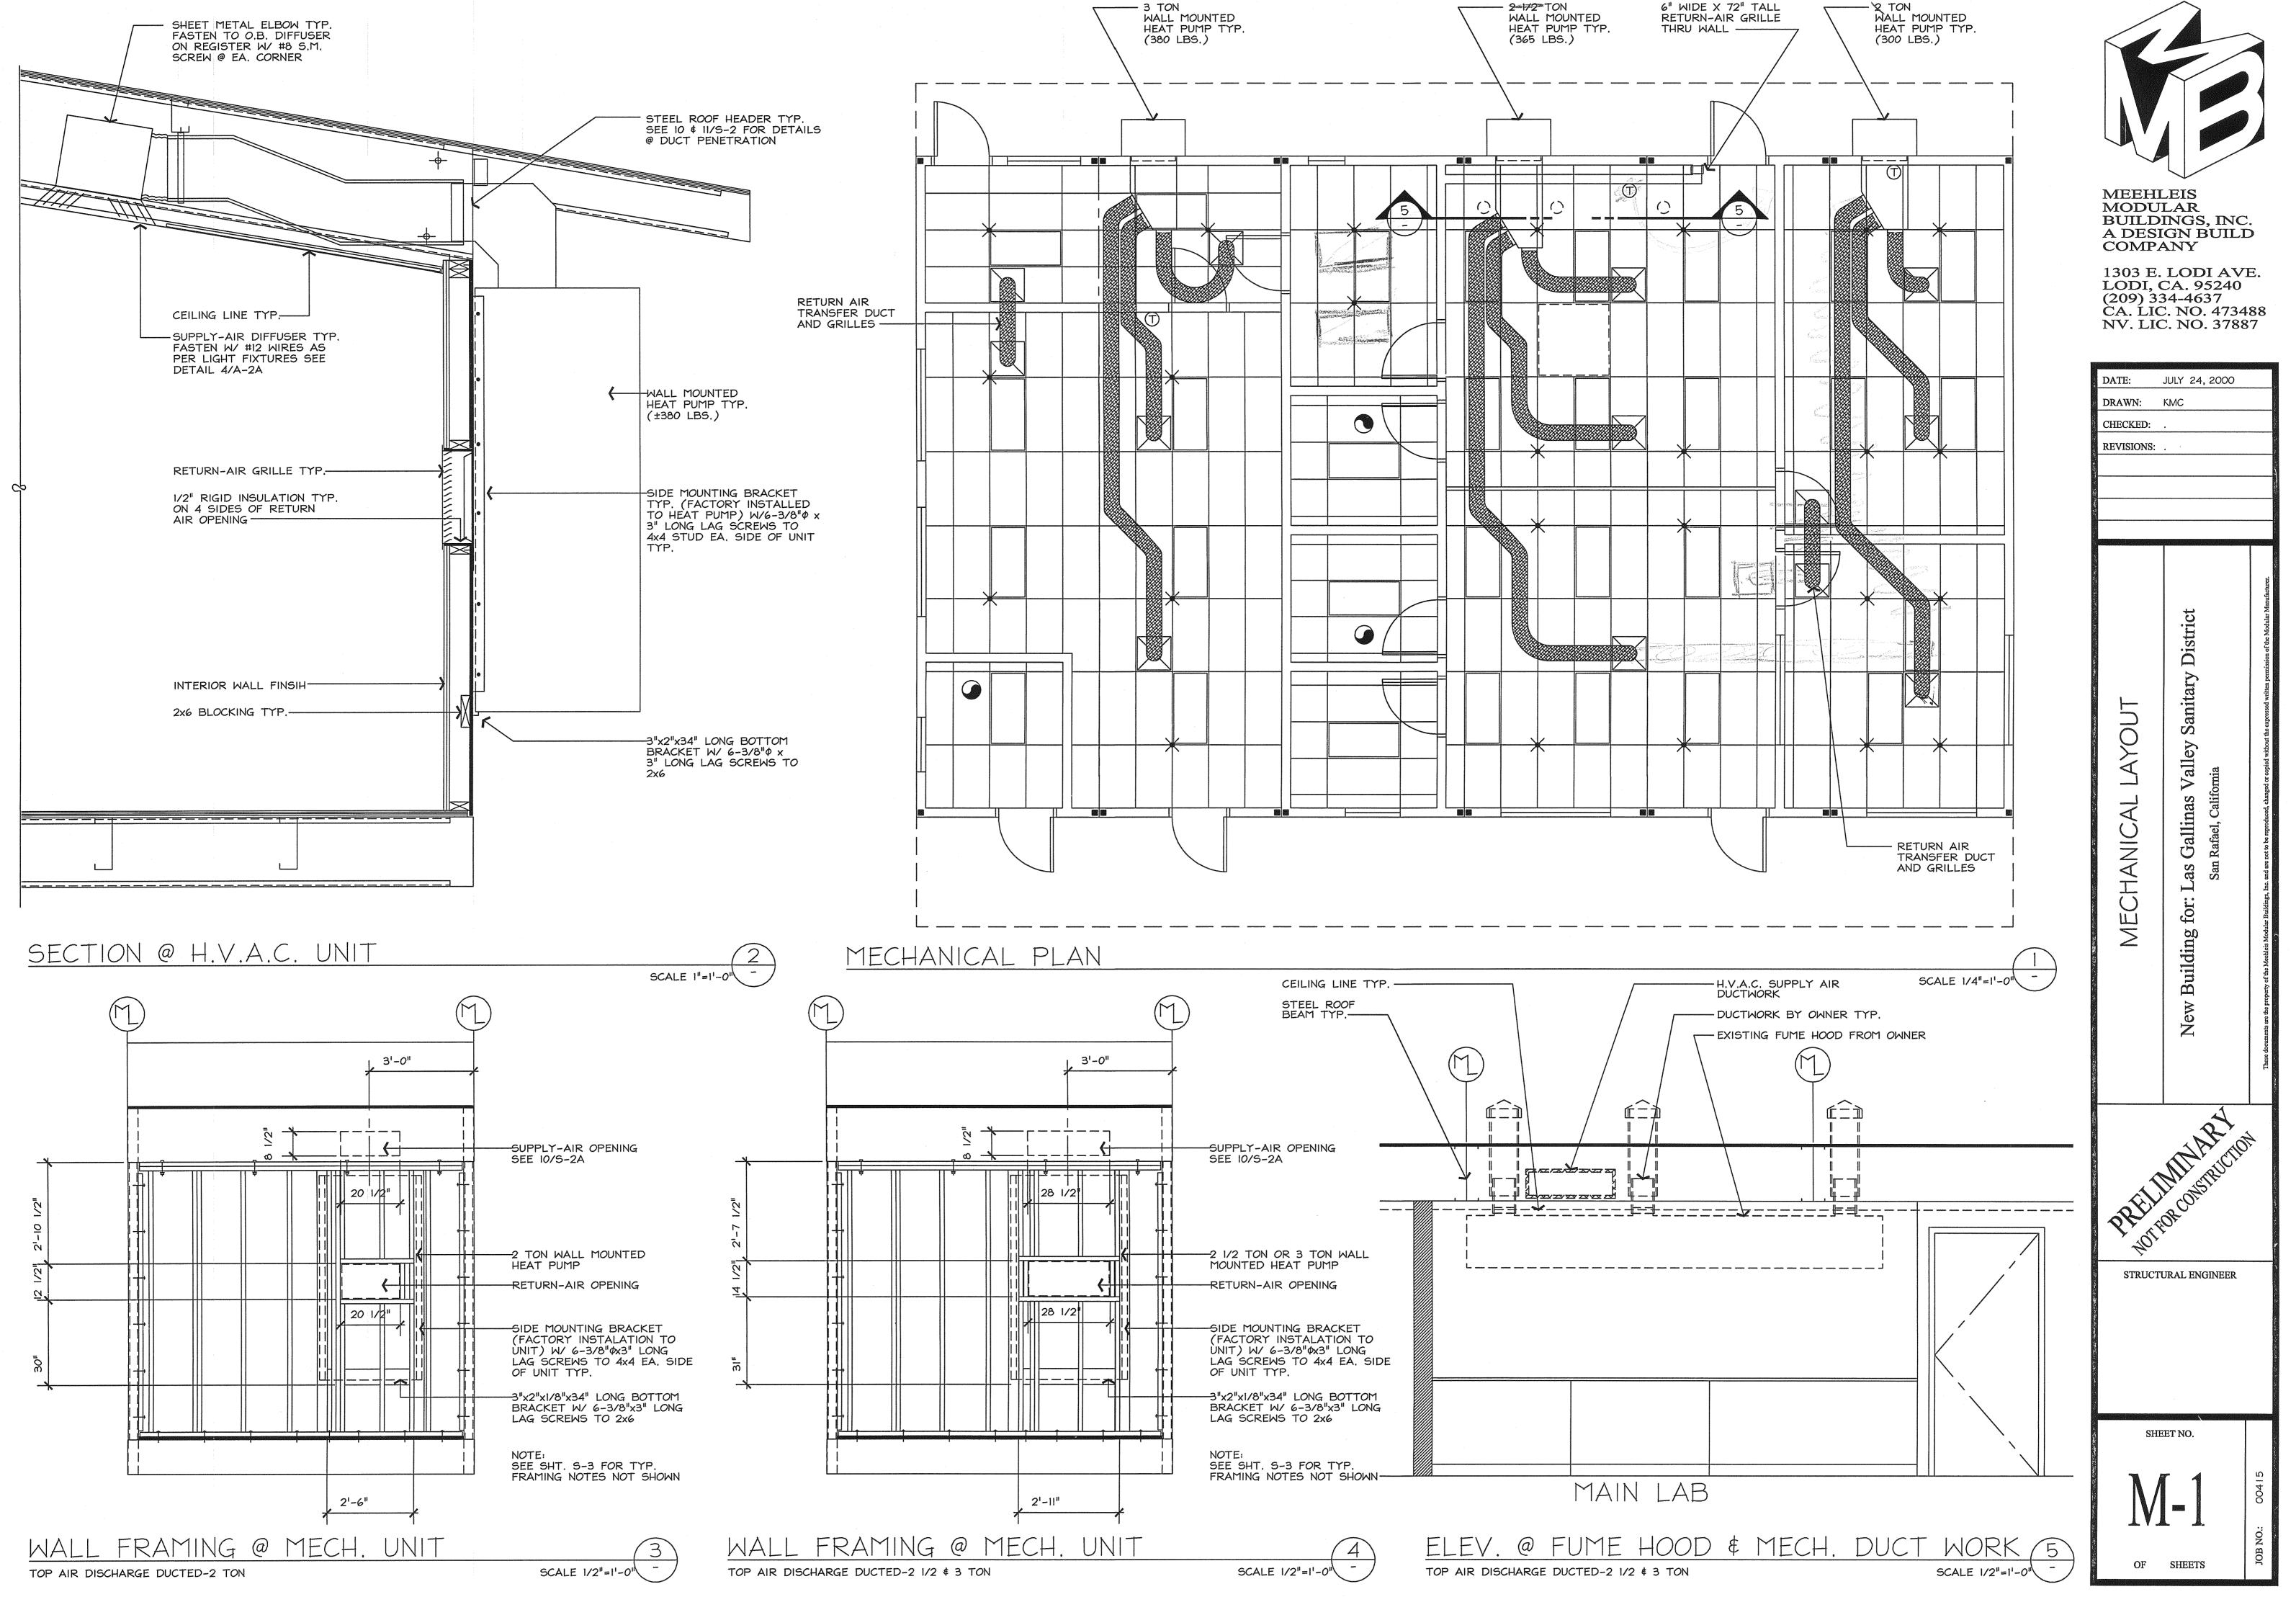MEEHLEIS

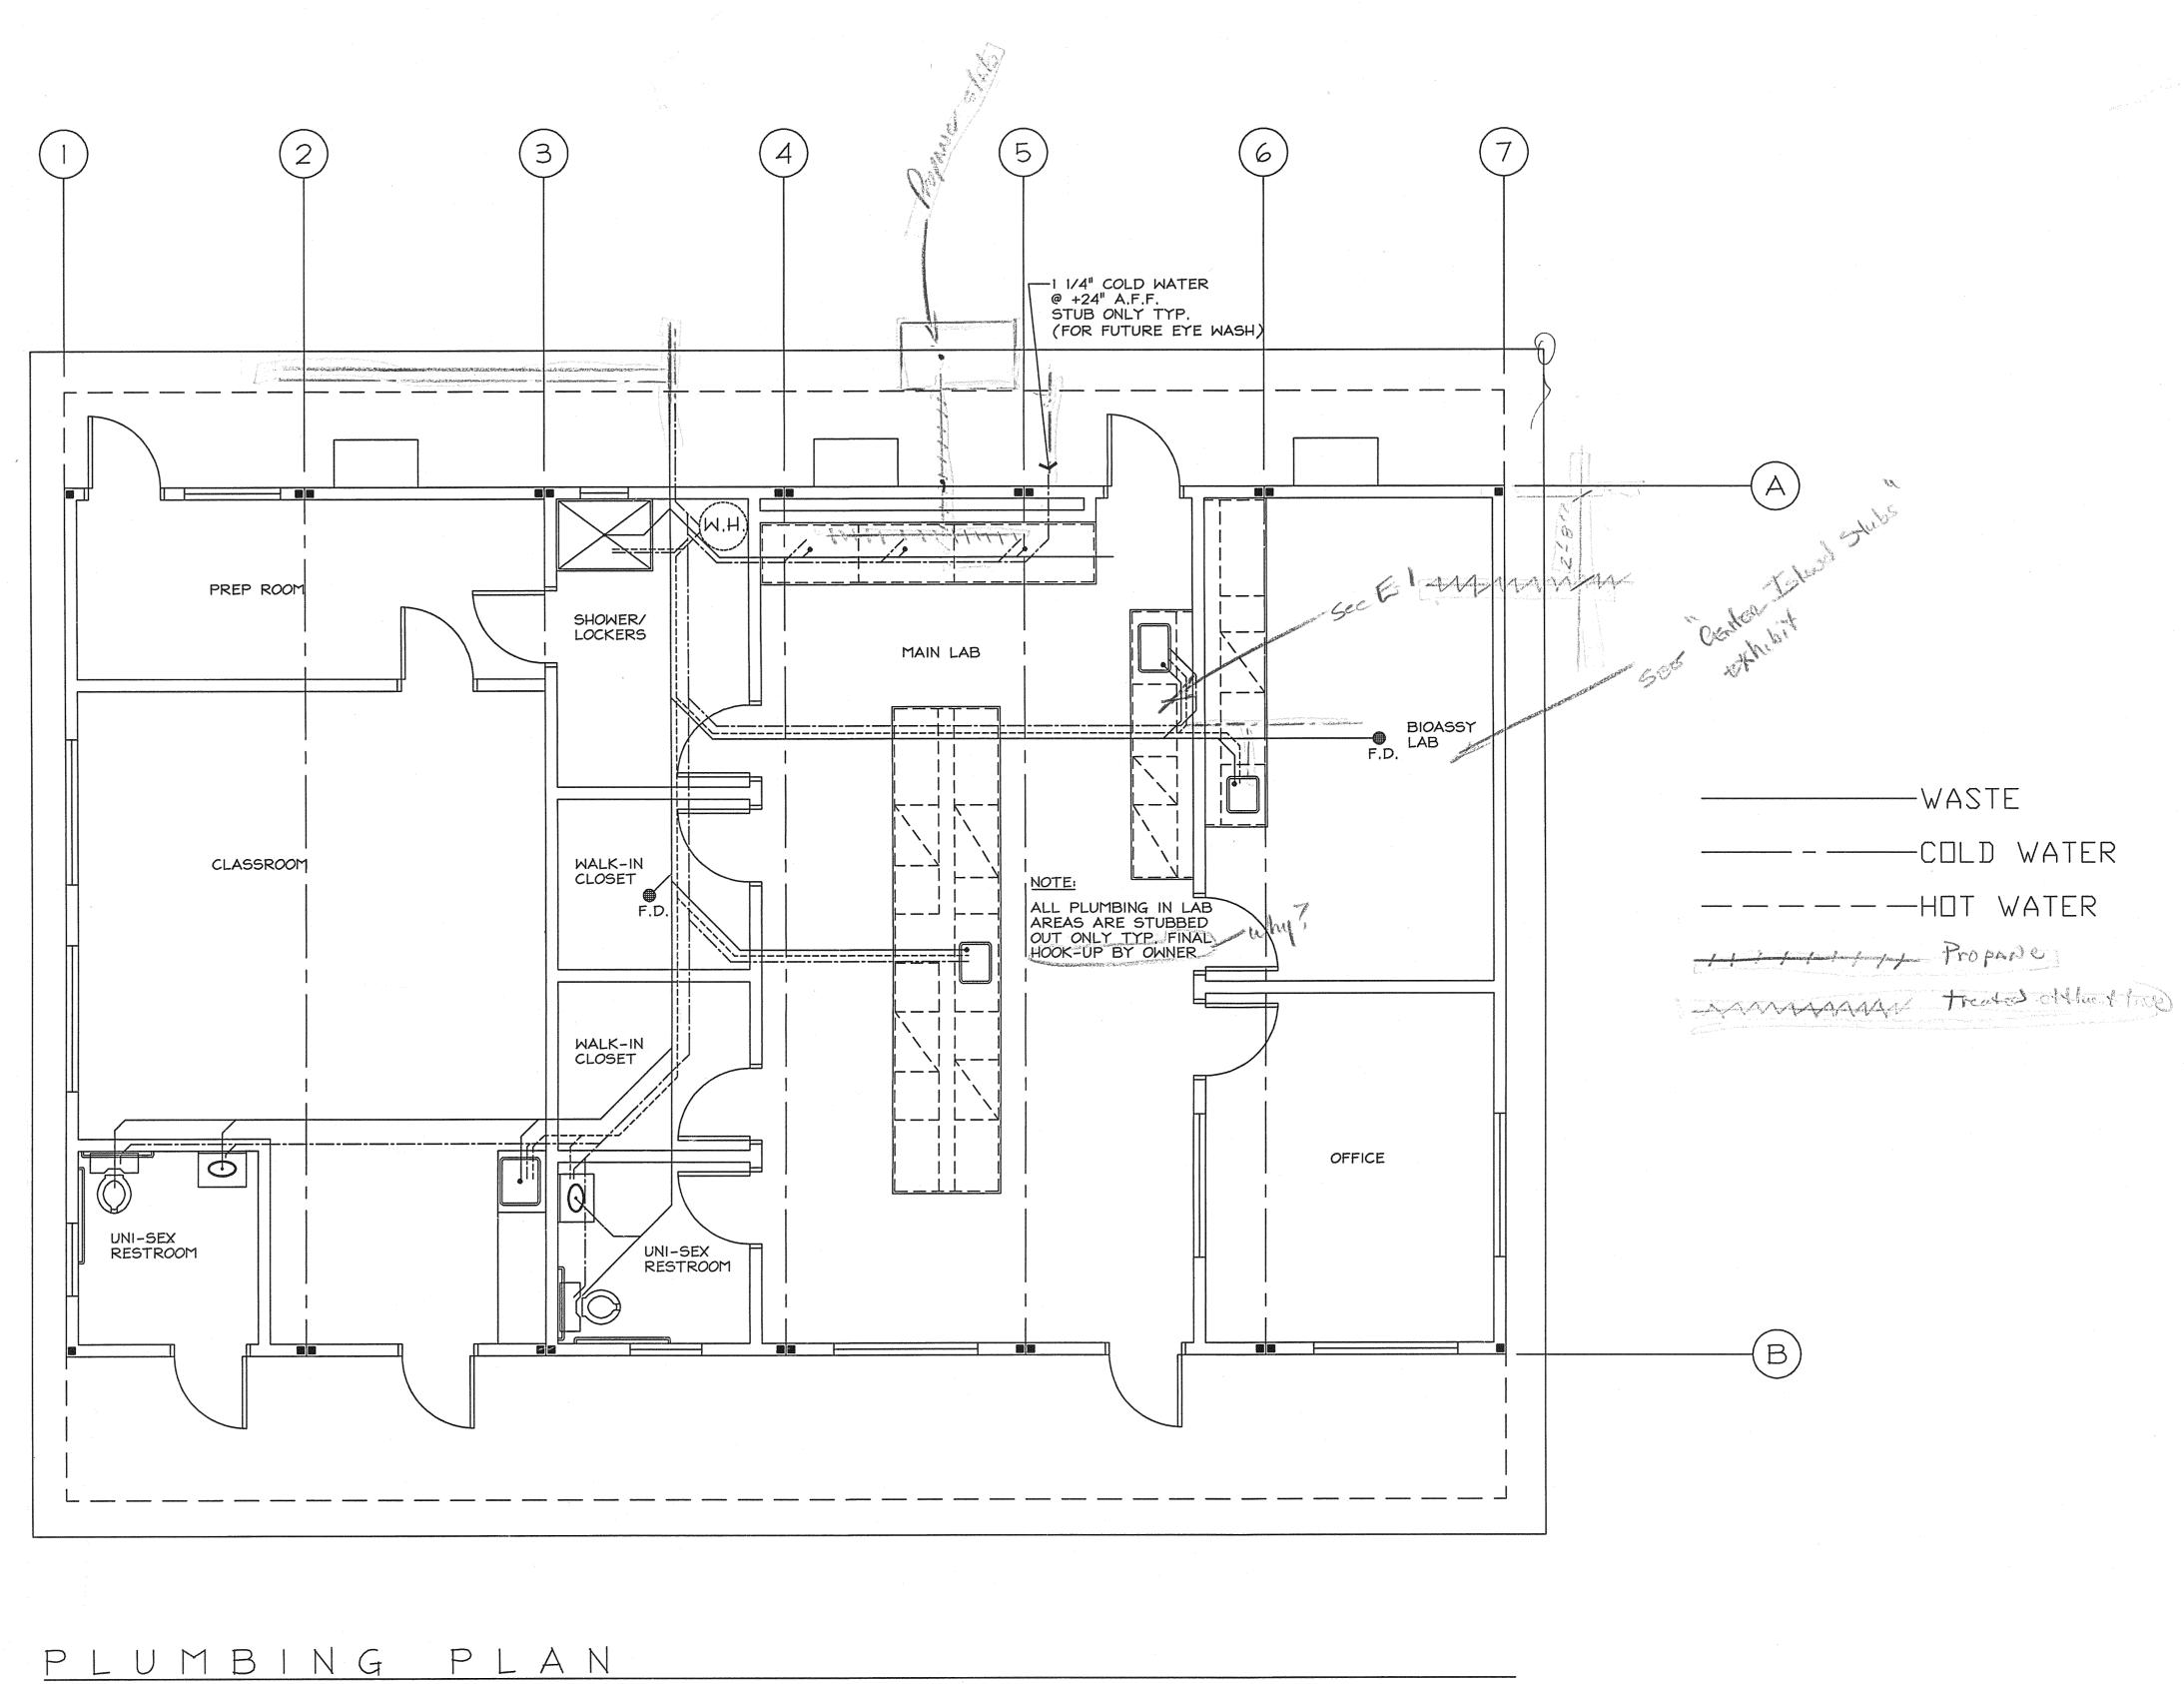MEEHLEIS MODULAR BUILDINGS, INC. A DESIGN BUILD COMPANY

DATE: DRAWN: CHECKED: REVISIONS:	JULY 24, 2000 KMC	
PLUMBING PLAN	New Building for: Las Gallinas Valley Sanitary District San Rafael, California	These documents are the property of the Moeble's Modular Buildings. In a said are not to be reproduced observed without the expressed written permission of the Modular Manufacture.
	INTERPRETATION OF THE PROPERTY	
SH	EET NO.	0.: 00415

ELECTRICAL SYMBOLS: EXTERIOR LIGHT FIXTURE (W/ PHOTO CELL WHERE) MOUNT @ + 8'-0" A.F.F. (INDICATED BY "PC" FIRE ALARM MANUAL PULL STATION MOUNT @ + 48" A.F.F. FIRE ALARM HORN (EXTERIOR) MOUNT @ + 7'-6" A.F.F. FIRE ALARM VISUAL STROBE LIGHT MOUNT @ + 80" A.F.F. EXIT SIGN MOUNT @ + 7'-6" A.F.F. JUNCTION BOX TELEPHONE / INTERCOM HANDSET MOUNT @ + 48" A.F.F. COMPUTER OUTLET COMPATER METWORK OUTLET THERMOSTAT - MOUNT @ 48" A.F.F. (UNSEALED) OR 60" A.F.F. (SEALED)

ELECTRICAL WALL RECEPTACLE MOUNT @ 12" A.F.F. TYP. U.O.N. ON PLANS

ELECTRICAL WALL RECEPTACLE (220 VOLTS)

3 WAY TOGGLE SWITCH MOUNT @ + 48" A.F.F.

TOGGLE SWITCH MOUNT @ + 48" A.F.F.

SURFACE MOUNTED LIGHT FIXTURE 1ºX4º

RECESSED CEILING LIGHT FIXTURE 2ºX4°


CLOCK OUTLET MOUNT @ + 7'-6" A.F.F

EXTERIOR FLOOD LIGHT W/ PHOTO CELL WHERE NOUNT @ + 8'-0" A.F.F. INDICATED BY "PC"

ELECTRICAL PANEL

ELECTRICAL WALL RECEPTACLE W/ SURGE PROTECTOR MOUNT @ 12" A.F.F. TYP U.O.N. ON PLANS

ELECTRICAL WALL RECEPTACLE W/ GROUND FAULT INTERUPTER MOUNT @ 12" A.F.F. TYP U.O.N. ON PLANS

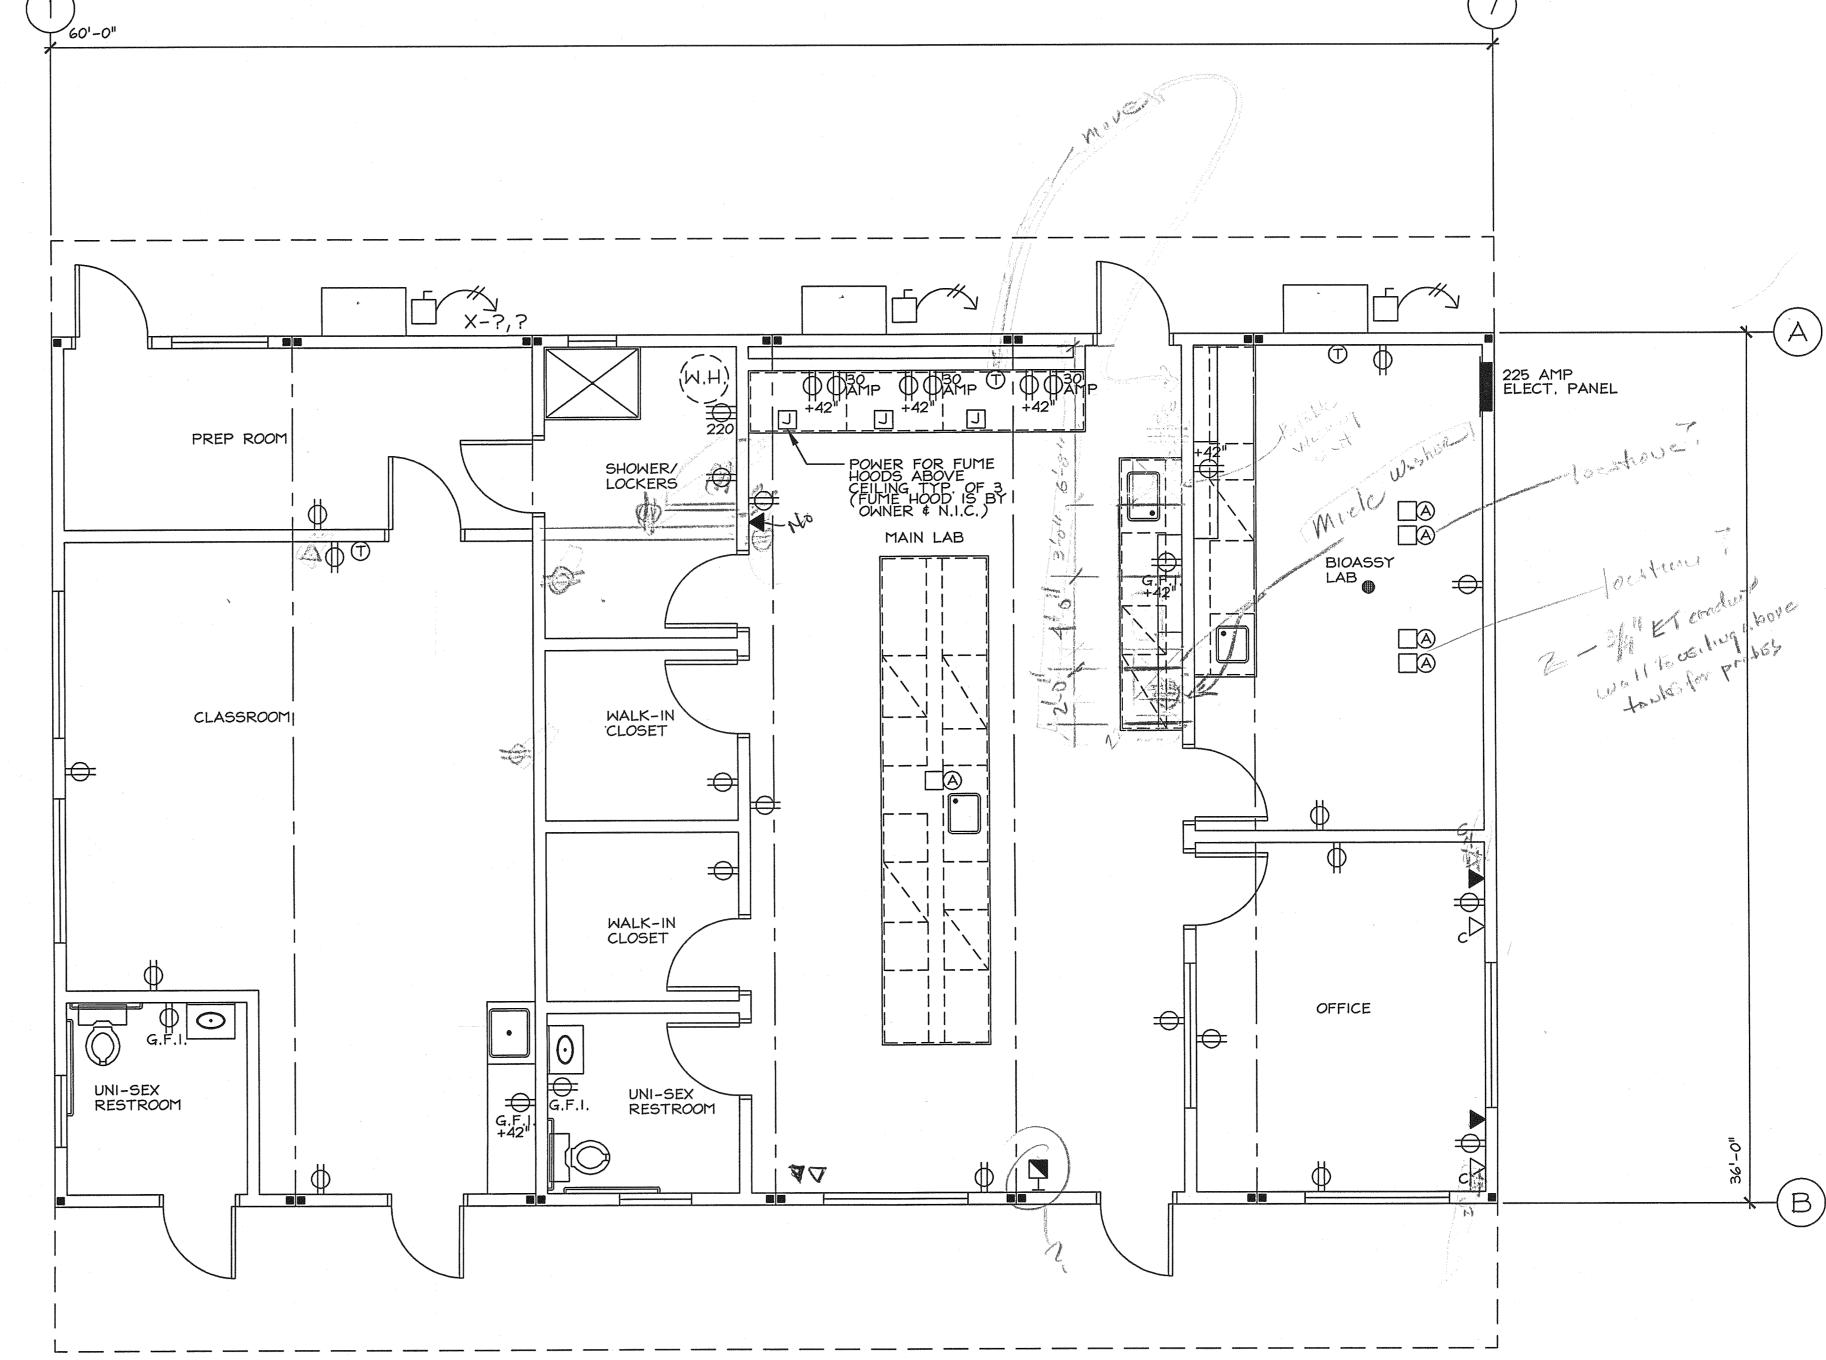

SCALE 1/4"=1'-0"

MEEHLEIS

MODULAR BUILDINGS, INC. A DESIGN BUILD COMPANY

1303 E. LODI AVE. LODI, CA. 95240 (209) 334-4637 CA. LIC. NO. 473488 NV. LIC. NO. 37887


STRUCT	PREI	ELECTRICAL POWER PLAN
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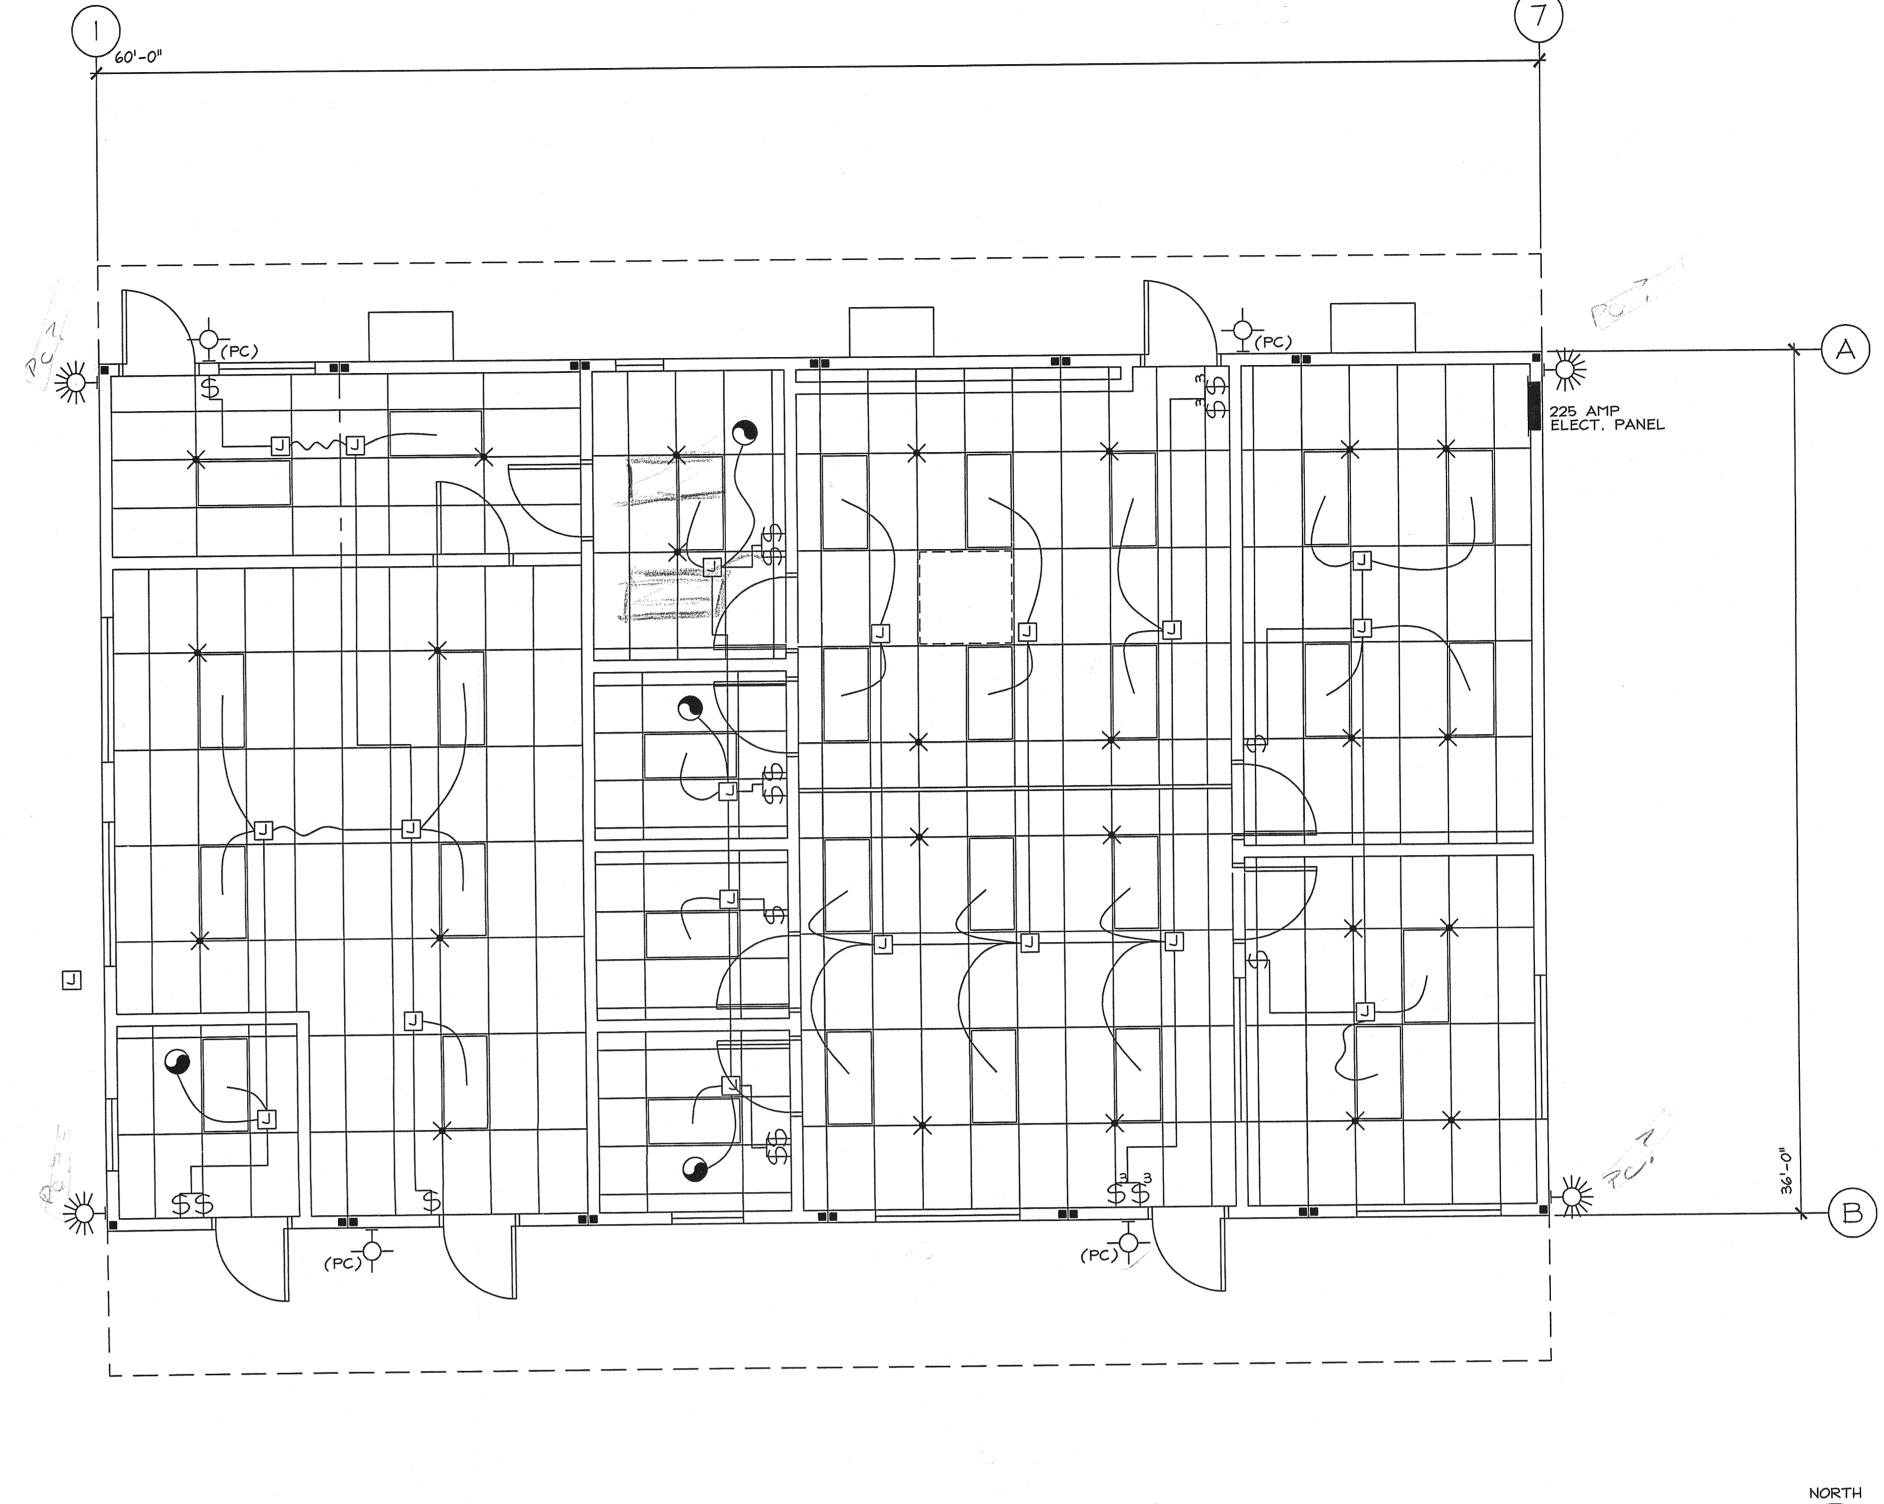
POWER PLAN

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ELECTRICAL SYMBOLS:





MEEHLEIS MODULAR BUILDINGS, INC. A DESIGN BUILD COMPANY

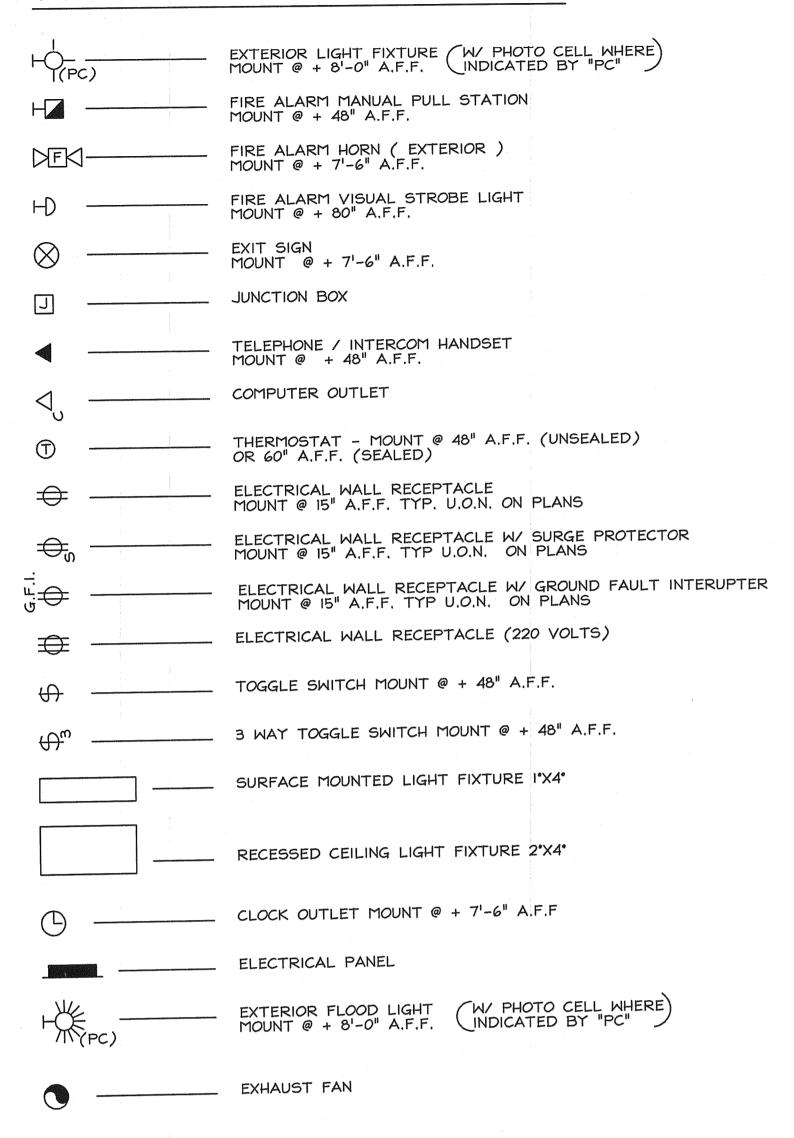1303 E. LODI AVE. LODI, CA. 95240 (209) 334-4637 CA. LIC. NO. 473488 NV. LIC. NO. 37887

DATE:	JULY 24, 2000
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STRU	CTURAL ENGINEER

SCALE 1/4"=1'-0"

F_7

OF SHEETS

LIGHTING LAYOUT

RECORDING REQUESTED BY AND RETURN TO:

PACIFIC GAS AND ELECTRIC COMPANY 245 Market Street, N10A, Room 1015 P.O. Box 770000 San Francisco, California 94177

Location: City/Uninc		
Recording Fee \$		
Document Transfer Tax \$		
[] This is a conveyance where the consideration and		
Value is less than \$100.00 (R&T 11911).		
[] Computed on Full Value of Property Conveyed, or		
[] Computed on Full Value Less Liens		
& Encumbrances Remaining at Time of Sale		
[] Exempt from the fee per GC 27388.1 (a) (2); This		
document is subject to Documentary Transfer Tax		
,		

(SPACE ABOVE FOR RECORDER'S USE ONLY)

Signature of declarant or agent determining tax

LD# 2402-06-10105

EASEMENT DEED

PM# 35110428

LAS GALLINAS VALLEY SANITARY DISTRICT, a California special district created pursuant to Health & Safety Code Sec. 6400, et seq., hereinafter called Grantor, hereby grants to PACIFIC GAS AND ELECTRIC COMPANY, a California corporation, hereinafter called Grantee, the right from time to time to excavate for, construct, reconstruct, replace (of initial or any other size), remove, maintain, inspect, and use facilities and associated equipment for public utility purposes, including, but not limited to electric, gas, and communication facilities, together with a right of way therefor, on, over, and under the easement area as hereinafter set forth, and also ingress thereto and egress therefrom, over and across the lands of Grantor situated in the City of San Rafael, County of Marin, State of California, described as follows:

(APN 155-121-20, -27, -29)

Lands of LAS GALLINAS SANITARY DISTRICT as shown upon the Record of Survey Map filed for record October 14, 2016 in Book 2016 of Maps at page 118, Marin County Records.

The easement area is described as follows:

The strips of land described in EXHIBIT "A", EXHIBIT "C", EXHIBIT "E", and EXHIBIT "G" and shown on EXHIBIT "B", EXHIBIT "D", EXHIBIT "F", and EXHIBIT "H" attached hereto and made a part hereof.

Grantor hereby confirms in Grantee all necessary rights for Grantee's existing pole line and other appurtenances located on said lands as shown on the EXHIBIT "I" attached hereto and made a part hereof.

Grantor further grants to Grantee the right, from time to time, to trim or to cut down, without Grantee paying compensation, any and all trees and brush now or hereafter within said easement area, and shall have the further right, from time to time, to trim and cut down trees and brush along each side of said

Utility Distribution Easement (02/2020)

easement area which now or hereafter in the opinion of Grantee may interfere with or be a hazard to the facilities installed hereunder, or as Grantee deems necessary to comply with applicable state or federal regulations.

Grantor also grants to Grantee the right to use such portion of said lands contiguous to said easement area as may be reasonably necessary in connection with the excavation, construction, reconstruction, replacement, removal, maintenance and inspection of said facilities.

Grantor hereby covenants and agrees not to place or construct, nor allow a third party to place or construct, any building or other structure, or store flammable substances, or drill or operate any well, or construct any reservoir or other obstruction within said easement area, or diminish or substantially add to the ground level within said easement area, or construct any fences that will interfere with the maintenance and operation of said facilities.

Grantor further grants to Grantee the right to apportion to another public utility (as defined in Section 216 of the California Public Utilities Code) the right to excavate for, construct, reconstruct, replace, remove, maintain, inspect, and use the communications facilities within said easement area including ingress thereto and egress therefrom.

Grantor acknowledges that they have read the "Grant of Easement Disclosure Statement", Exhibit "J", attached hereto and made a part hereof.

This document may be executed in multiple counterparts, each of which shall be deemed an original, but all of which, together, shall constitute one and the same instrument.

Utility Distribution Easement (02/2020)

The provisions hereof shall inure to the benefit of and bind the successors and assigns of the respective parties hereto, and all covenants shall apply to and run with the land.

Dated: /////202.0.

LAS GALLINAS VALLEY SANITARY DISTRICT, a California Special District

By: By:

Rabi Elias President
Print Name and Title

Print Name and Title



I hereby certify that a resolution was adopted on the 5 day of November, 20 Z°, by the Las Callings Valley Sandry Dished authorizing the foregoing grant of easement.

By Level, Board Secretary

BIGGS STORES STO	CIVIL CODE § 1189	
A notary public or other officer completing this certificate ver to which this certificate is attached, and not the truthfulness	rifies only the identity of the individual who signed the document s, accuracy, or validity of that document.	
State of California		
County of Marin		
On November 11, 2020 before me, Date	my Learne Schutty Notary Public Here Insert Name and Title of the Officer	
personally appeared	Elias	
	Name(s) of Signer(s)	
to the within instrument and acknowledged to me the authorized capacity(ies), and that by his/her/their sign upon behalf of which the person(s) acted, executed the	nature(s) on the instrument the person(s), or the entity	
AMY LEANNE SCHULTZ Notary Public - California Marin County	I certify under PENALTY OF PERJURY under the laws of the State of California that the foregoing paragraph is true and correct. WITNESS my hand and official seal.	
Commission # 2323576 My Comm. Expires Mar 10, 2024		
Place Notary Seal and/or Stamp Above	Signature Signature of Notary Public	
	ONAL -	
fraudulent reattachment of this	deter alteration of the document or form to an unintended document.	
Description of Attached Document Title or Type of Document:		
Document Date:	Number of Pages:	
Signer(s) Other Than Named Above:	<u> </u>	
Capacity(ies) Claimed by Signer(s)		
Signer's Name:	Signer's Name:	
☐ Corporate Officer – Title(s):	□ Corporate Officer – Title(s):	
☐ Partner — ☐ Limited ☐ General	□ Partner - □ Limited □ General	
☐ Individual ☐ Attorney in Fact☐ Trustee ☐ Guardian or Conservator	☐ Individual ☐ Attorney in Fact	
□ Other:	☐ Trustee ☐ Guardian or Conservator	
Signer is Representing:	☐ Other:	

©2018 National Notary Association

EXHIBIT "A" LEGAL DESCRIPTION PG&E EASEMENT

BEING A PORTION OF THE LANDS OF LAS GALLINAS VALLEY SANITARY DISTRICT AS CONVEYED BY THAT CERTAIN DEED RECORDED AUGUST 22, 1958 IN BOOK 1212 OF OFFICIAL RECORDS AT PAGE 13, AS SHOWN ON RECORD OF SURVEY FILED IN BOOK 17 OF SURVEYS, AT PAGE 57, MARIN COUNTY RECORDS, LYING WITHIN SECTION 15, TOWNSHIP 2 NORTH, RANGE 5 WEST, MD, BEING A STRIP OF LAND 12.61 FEET WIDE LYING 6.305 FEET ON EACH SIDE OF THE FOLLOWING DESCRIBED CENTERLINE;

COMMENCING AT THE SOUTHWESTERLY CORNER OF PARCEL TEN OF SAID GRANT DEED, SAID CORNER BEING ON THE BOUNDARY LINE OF THE LANDS OF LAS GALLINAS VALLEY SANITARY DISTRICT AS CONVEYED BY GRANT DEED AND DEED OF EASEMENTS RECORDED AUGUST 22, 1958 IN BOOK 1212 AT PAGE 13 AS SHOWN ON BOOK 17 OF SURVEYS AT PAGE 57, OF SAID OFFICIAL RECORDS;

THENCE THE FOLLOWING TWO (2) COURSES ALONG THE SOUTHERLY LINE OF SAID PARCEL TEN;

- 1) NORTH 75°30'00" EAST, A DISTANCE OF 110.05 FEET:
- 2) SOUTH 50°00'00" EAST, A DISTANCE OF 3.93 FEET;

THENCE LEAVING SAID SOUTHERLY LINE NORTH 36°45'11" EAST, A DISTANCE OF 30.86 FEET;

THENCE NORTH 41°15'29" EAST, A DISTANCE OF 94.24 FEET;

THENCE NORTH 39°59'00" EAST, A DISTANCE OF 13.52 FEET TO A POINT ON THE NORTHWESTERLY LINE OF SAID PARCEL TEN;

THENCE LEAVING SAID NORTHWESTERLY LINE OF SAID PARCEL TEN AND CONTINUING NORTH 39°59'00" EAST, A DISTANCE OF 154.46 FEET TO THE BEGINNING OF A NON-TANGENT CURVE, CONCAVE SOUTHERLY, HAVING A RADIUS OF 113.50 FEET, TO WHICH A RADIAL LINE BEARS NORTH 44°50'15" WEST;

THENCE NORTHEASTERLY, EASTERLY AND SOUTHEASTERLY ALONG SAID CURVE, TO THE RIGHT, THROUGH A CENTRAL ANGLE OF 88°03'50", AN ARC DISTANCE OF 174.45 FEET TO A POINT WHICH A RADIAL LINE BEARS NORTH 43°13'55" EAST;

THENCE SOUTH 53°21'38" EAST, A DISTANCE OF 24.93 FEET:

1 OF 2

G:\2015\15-0154\Drawings\Mapping\PLATS N LEGALS\REVISED PGE ALR\PGE #4A\15-154 LEGAL PGE EASEMENT #4A.docx Albert A. Webb Associates

EXHIBIT "A" LEGAL DESCRIPTION PG&E EASEMENT

THENCE SOUTH 50°06'33" EAST, A DISTANCE OF 80.58 FEET:

THENCE SOUTH 49°48'36" EAST, A DISTANCE OF 38.50 FEET;

THENCE SOUTH 40°56'18" WEST, A DISTANCE OF 9.59 FEET TO THE NORTHERLY LINE OF SAID LANDS OF LAS GALLINAS VALLEY SANITARY DISTRICT AND THE TRUE POINT OF BEGINNING;

THENCE CONTINUING SOUTH 40°56'18" WEST, A DISTANCE OF 21.86 FEET TO THE POINT OF TERMINUS;

THE SIDELINES OF SAID STRIP OF LAND SHALL BE PROLONGED OR SHORTENED SO AS TO TERMINATE AT THE NORTHERLY LINE OF SAID LANDS OF LAS GALLINAS VALLEY SANITARY DISTRICT.

CONTAINING 276 SQUARE FEET, MORE OR LESS.

APN 155-121-27 & -29

THE BASIS OF BEARINGS FOR THE HEREIN DESCRIBED LEGAL DESCRIPTION IS TAKEN FROM DATA SHOWN ON THAT CERTAIN RECORD OF SURVEY FILED IN BOOK 17 OF SURVEYS AT PAGE 57, MARIN COUNTY RECORDS.

SEE PLAT ATTACHED HERETO AS EXHIBIT "B" AND MADE A PART HEREOF. PREPARED UNDER MY SUPERVISION

MICHAEL E. JOHNSON, L.S. 7673

6/16/20 DATE

PREPARED BY: AL

CHECKED BY: WA



2 of 2

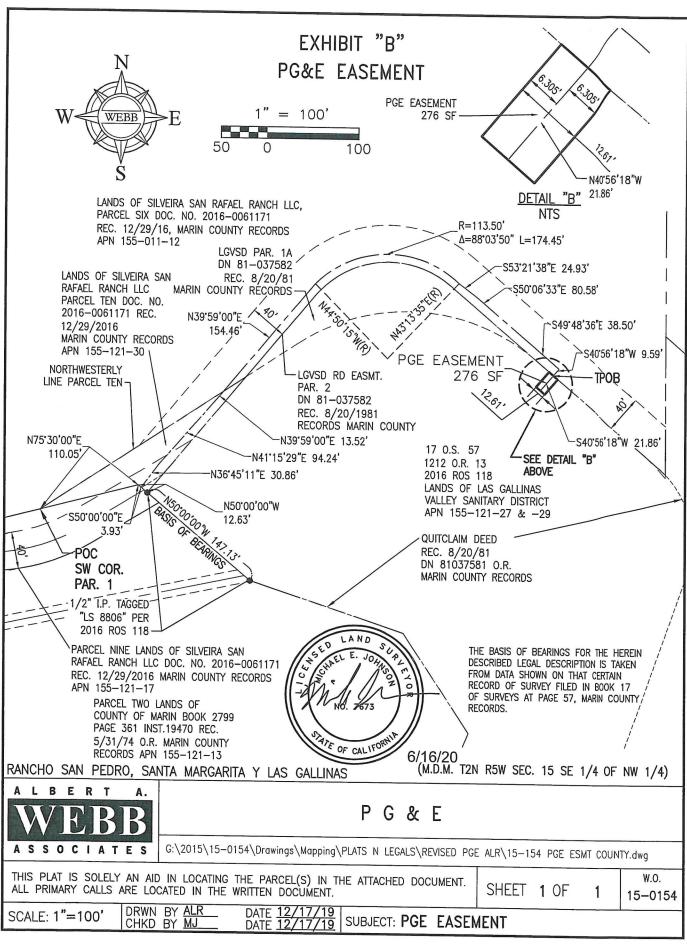


EXHIBIT "C" LEGAL DESCRIPTION PG&E EASEMENT

BEING A PORTION OF THE LANDS OF LAS GALLINAS VALLEY SANITARY DISTRICT AS CONVEYED BY THAT CERTAIN DEED RECORDED AUGUST 22, 1958 IN BOOK 1212 OF OFFICIAL RECORDS AT PAGE 13, AS SHOWN ON RECORD OF SURVEY FILED IN BOOK 17 OF SURVEYS, AT PAGE 57, MARIN COUNTY RECORDS, LYING WITHIN SECTION 15, TOWNSHIP 2 NORTH, RANGE 5 WEST, MD, BEING A STRIP OF LAND 10.00 FEET WIDE LYING 5.00 FEET ON EACH SIDE OF THE FOLLOWING DESCRIBED CENTERLINE;

COMMENCING AT THE SOUTHWESTERLY CORNER OF PARCEL TEN OF SAID GRANT DEED, SAID CORNER BEING ON THE BOUNDARY LINE OF THE LANDS OF LAS GALLINAS VALLEY SANITARY DISTRICT AS CONVEYED BY GRANT DEED AND DEED OF EASEMENTS RECORDED AUGUST 22, 1958 IN BOOK 1212 AT PAGE 13 AS SHOWN ON BOOK 17 OF SURVEYS AT PAGE 57, OF SAID OFFICIAL RECORDS;

THENCE THE FOLLOWING TWO (2) COURSES ALONG THE SOUTHERLY LINE OF SAID PARCEL TEN;

- 1) NORTH 75°30'00" EAST, A DISTANCE OF 110.05 FEET;
- 2) SOUTH 50°00'00" EAST, A DISTANCE OF 3.93 FEET;

THENCE LEAVING SAID SOUTHERLY LINE NORTH 36°45'11" EAST, A DISTANCE OF 30.86 FEET;

THENCE NORTH 41°15'29" EAST, A DISTANCE OF 94.24 FEET;

THENCE NORTH 39°59'00" EAST, A DISTANCE OF 13.52 FEET TO A POINT ON THE NORTHWESTERLY LINE OF SAID PARCEL TEN:

THENCE LEAVING SAID NORTHWESTERLY LINE OF SAID PARCEL TEN AND CONTINUING NORTH 39°59'00" EAST, A DISTANCE OF 154.46 FEET TO THE BEGINNING OF A NON-TANGENT CURVE, CONCAVE SOUTHERLY, HAVING A RADIUS OF 113.50 FEET, TO WHICH A RADIAL LINE BEARS NORTH 44°50'15" WEST;

THENCE NORTHEASTERLY, EASTERLY AND SOUTHEASTERLY ALONG SAID CURVE, TO THE RIGHT, THROUGH A CENTRAL ANGLE OF 88°03'50", AN ARC DISTANCE OF 174.45 FEET TO A POINT WHICH A RADIAL LINE BEARS NORTH 43°13'55" EAST;

THENCE SOUTH 53°21'38" EAST, A DISTANCE OF 24.93 FEET;

THENCE SOUTH 50°06'33" EAST, A DISTANCE OF 80.58 FEET;

1 OF 2

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EXHIBIT "C" LEGAL DESCRIPTION PG&E EASEMENT

THENCE SOUTH 49°48'36" EAST, A DISTANCE OF 38.50 FEET TO A POINT THEREON;

THENCE CONTINUING SOUTH 49°48'36" EAST, A DISTANCE OF 45.29 FEET;

THENCE SOUTH 50°09'20" EAST, A DISTANCE OF 67.51 FEET;

THENCE SOUTH 49°14'36" EAST, A DISTANCE OF 45.77 FEET TO A POINT ON THE EASTERLY LINE OF PARCEL SIX AS CONVEYED BY THAT CERTAIN GRANT DEED TO SILVEIRA SAN RAFAEL RANCH LLC RECORDED DECEMBER 29, 2016 AS DOCUMENT 2016-0061171 OF OFFICIAL RECORDS OF THE COUNTY OF MARIN, CALIFORNIA FOR THE TRUE POINT OF BEGINNING;

THENCE SOUTH 49°14'36" EAST, A DISTANCE OF 3.38 FEET;

THENCE SOUTH 43°40'23" EAST, A DISTANCE OF 19.59 FEET;

THENCE SOUTH 32°20'53" EAST, A DISTANCE OF 1.98 FEET;

THENCE SOUTH 65°24'39" EAST, A DISTANCE OF 85.83 FEET TO A POINT OF TERMINUS;

THE SIDELINES OF SAID STRIP OF LAND SHALL BE PROLONGED OR SHORTENED SO AS TO TERMINATE AT THE SAID EASTERLY LINE.

CONTAINING 1,108 SQUARE FEET, MORE OR LESS.

APN 155-121-27 & -29

THE BASIS OF BEARINGS FOR THE HEREIN DESCRIBED LEGAL DESCRIPTION IS TAKEN FROM DATA SHOWN ON THAT CERTAIN RECORD OF SURVEY FILED IN BOOK 17 OF SURVEYS AT PAGE 57, MARIN COUNTY RECORDS.

SEE PLAT ATTACHED HERETO AS EXHIBIT "D" AND MADE A PART HEREOF.

PREPARED UNDER MY SUPERVISION

MICHAEL E. JOHNSON, L.S. 7673

6/16/20 DATE

PREPARED BY: AL CHECKED BY: MA

2 of 2

\\elsinore\WO2\2015\\15-0154\Drawings\Mapping\PLATS N LEGALS\REVISED PGE ALR\PGE #5\\15-154 LEGAL PGE EASEMENT #5.docx Albert A. Webb Associates

NO. 7673

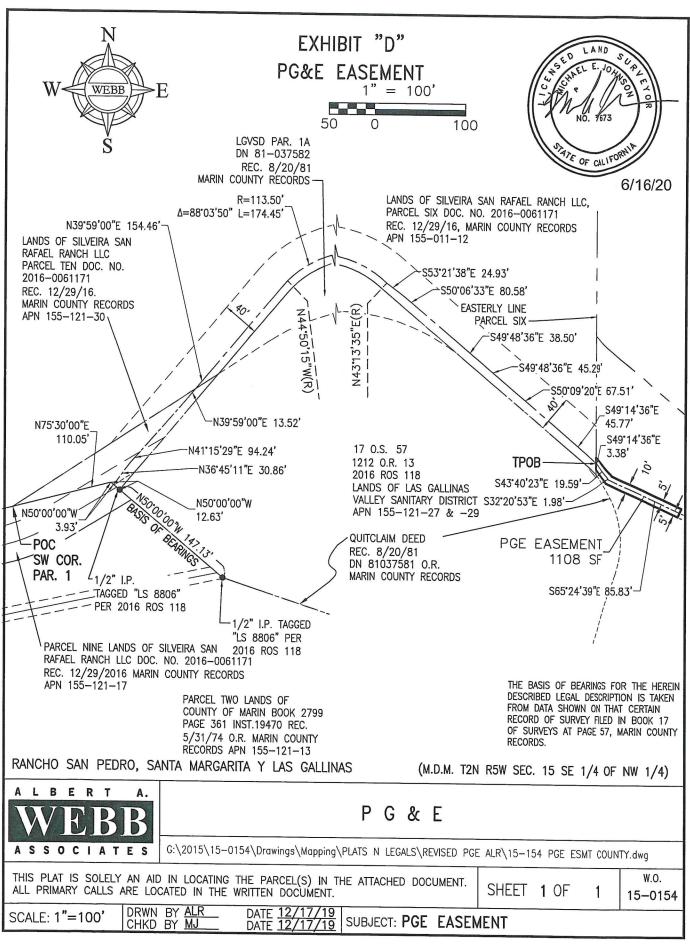


EXHIBIT "E" LEGAL DESCRIPTION PG&E EASEMENT

BEING A PORTION OF THE LANDS OF LAS GALLINAS VALLEY SANITARY DISTRICT AS CONVEYED BY THAT CERTAIN DEED RECORDED AUGUST 22, 1958 IN BOOK 1212 OF OFFICIAL RECORDS AT PAGE 13, AS SHOWN ON RECORD OF SURVEY FILED IN BOOK 17 OF SURVEYS, AT PAGE 57, MARIN COUNTY RECORDS, LYING WITHIN SECTION 15, TOWNSHIP 2 NORTH, RANGE 5 WEST, MD, BEING A STRIP OF LAND 30.00 FEET WIDE LYING 15.00 FEET ON EACH SIDE OF THE FOLLOWING DESCRIBED CENTERLINE;

COMMENCING AT THE SOUTHWESTERLY CORNER OF PARCEL TEN OF SAID GRANT DEED, SAID CORNER BEING ON THE BOUNDARY LINE OF THE LANDS OF LAS GALLINAS VALLEY SANITARY DISTRICT AS CONVEYED BY GRANT DEED AND DEED OF EASEMENTS RECORDED AUGUST 22, 1958 IN BOOK 1212 AT PAGE 13 AS SHOWN ON BOOK 17 OF SURVEYS AT PAGE 57, OF SAID OFFICIAL RECORDS;

THENCE THE FOLLOWING TWO (2) COURSES ALONG THE SOUTHERLY LINE OF SAID PARCEL TEN;

- 1) NORTH 75°30'00" EAST, A DISTANCE OF 110.05 FEET;
- 2) SOUTH 50°00'00" EAST, A DISTANCE OF 3.93 FEET;

THENCE LEAVING SAID SOUTHERLY LINE NORTH 36°45'11" EAST, A DISTANCE OF 30.86 FEET;

THENCE NORTH 41°15'29" EAST, A DISTANCE OF 94.24 FEET;

THENCE NORTH 39°59'00" EAST, A DISTANCE OF 13.52 FEET TO A POINT ON THE NORTHWESTERLY LINE OF SAID PARCEL TEN:

THENCE LEAVING SAID NORTHWESTERLY LINE OF SAID PARCEL TEN AND CONTINUING NORTH 39°59'00" EAST, A DISTANCE OF 154.46 FEET TO THE BEGINNING OF A NON-TANGENT CURVE, CONCAVE SOUTHERLY, HAVING A RADIUS OF 113.50 FEET, TO WHICH A RADIAL LINE BEARS NORTH 44°50'15" WEST;

THENCE NORTHEASTERLY, EASTERLY AND SOUTHEASTERLY ALONG SAID CURVE, TO THE RIGHT, THROUGH A CENTRAL ANGLE OF 88°03'50", AN ARC DISTANCE OF 174.45 FEET TO A POINT WHICH A RADIAL LINE BEARS NORTH 43°13'55" EAST;

THENCE SOUTH 53°21'38" EAST, A DISTANCE OF 24.93 FEET;

THENCE SOUTH 50°06'33" EAST, A DISTANCE OF 80.58 FEET;

1 OF 2

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EXHIBIT "E" LEGAL DESCRIPTION PG&E EASEMENT

THENCE SOUTH 49°48'36" EAST, A DISTANCE OF 38.50 FEET TO A POINT THEREON;

THENCE CONTINUING SOUTH 49°48'36" EAST, A DISTANCE OF 45.29 FEET;

THENCE SOUTH 50°09'20" EAST, A DISTANCE OF 67.51 FEET;

THENCE SOUTH 49°14'36" EAST, A DISTANCE OF 45.77 FEET TO A POINT ON THE EASTERLY LINE OF PARCEL SIX AS CONVEYED BY THAT CERTAIN GRANT DEED TO SILVEIRA SAN RAFAEL RANCH LLC RECORDED DECEMBER 29, 2016 AS DOCUMENT 2016-0061171 OF OFFICIAL RECORDS OF THE COUNTY OF MARIN, CALIFORNIA;

THENCE SOUTH 49°14'36" EAST, A DISTANCE OF 3.38 FEET;

THENCE SOUTH 43°40'23" EAST, A DISTANCE OF 19.59 FEET;

THENCE SOUTH 32°20'53" EAST, A DISTANCE OF 1.98 FEET;

THENCE SOUTH 67°26'08" EAST, A DISTANCE OF 66.24 FEET TO THE TRUE POINT OF BEGINNING;

THENCE SOUTH 80°13'54" EAST, A DISTANCE OF 112.15 FEET TO A POINT OF TERMINUS;

CONTAINING 3,364 SQUARE FEET, MORE OR LESS.

APN 155-121-27 & -29

THE BASIS OF BEARINGS FOR THE HEREIN DESCRIBED LEGAL DESCRIPTION IS TAKEN FROM DATA SHOWN ON THAT CERTAIN RECORD OF SURVEY FILED IN BOOK 17 OF SURVEYS AT PAGE 57, MARIN COUNTY RECORDS.

SEE PLAT ATTACHED HERETO AS EXHIBIT "F" AND MADE A PART HEREOF.

PREPARED UNDER MY SUPERVISION

MICHAEL E. JOHNSON, L.S. 7673

Online

6/16/20

DATE

PREPARED BY: AL CHECKED BY: 71

2 of 2

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NO. 7673

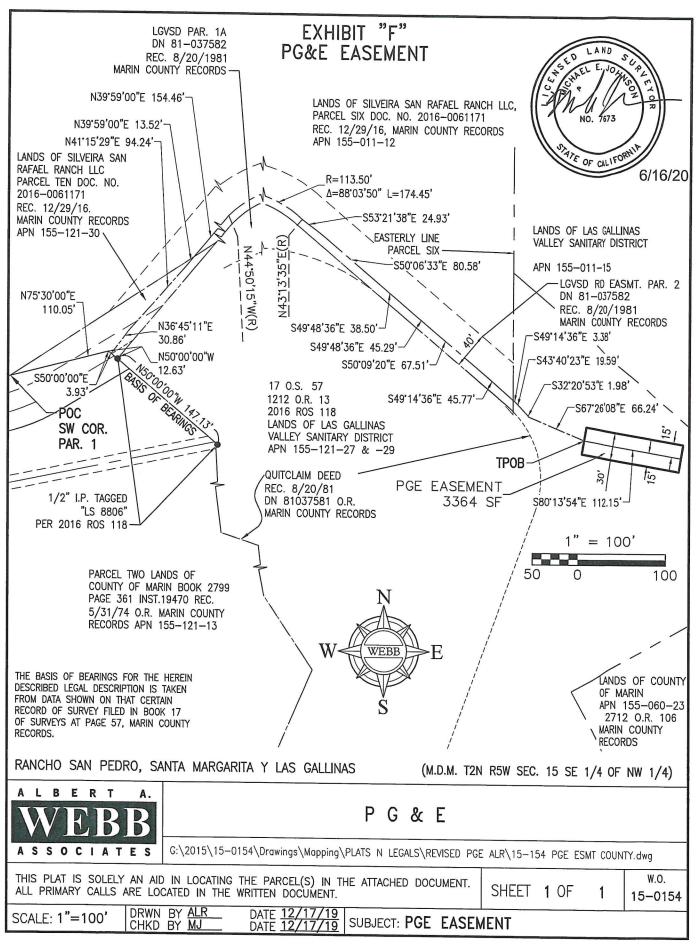


EXHIBIT "G" LEGAL DESCRIPTION PG&E EASEMENT

BEING A PORTION OF THE LANDS OF LAS GALLINAS VALLEY SANITARY DISTRICT AS CONVEYED BY THAT CERTAIN DEED RECORDED AUGUST 22, 1958 IN BOOK 1212 OF OFFICIAL RECORDS AT PAGE 13, AS SHOWN ON RECORD OF SURVEY FILED IN BOOK 17 OF SURVEYS, AT PAGE 57, MARIN COUNTY RECORDS, LYING WITHIN SECTION 15, TOWNSHIP 2 NORTH, RANGE 5 WEST, MD, BEING A STRIP OF LAND 10.00 FEET WIDE LYING 5.00 FEET ON EACH SIDE OF THE FOLLOWING DESCRIBED CENTERLINE:

COMMENCING AT THE MOST SOUTHERLY CORNER OF THE LANDS OF LAS GALLINAS VALLEY SANITARY DISTRICT 1212 O.R. 13 MARIN COUNTY RECORDS AS SHOWN ON THAT CERTAIN RECORD OF SURVEY FILED IN BOOK 17 OF SURVEYS AT PAGE 57, MARIN COUNTY RECORDS;

THENCE NORTH 62°15'00" WEST ALONG THE SOUTHWESTERLY BOUNDARY LINE OF SAID LANDS OF LAS GALLINAS VALLEY SANITARY DISTRICT AND SAID RECORD OF SURVEY, A DISTANCE OF 124.20 FEET;

THENCE LEAVING SAID BOUNDARY LINE SOUTH 87°40'11" EAST, A DISTANCE OF 118.97 FEET;

THENCE NORTH 28°04'09" EAST, A DISTANCE OF 175.00 FEET;

THENCE NORTH 48°00'03" WEST, A DISTANCE OF 117.04 FEET;

THENCE NORTH $00^{\circ}26'37"$ WEST, A DISTANCE OF 21.97 FEET TO THE **TRUE POINT OF BEGINNING**;

THENCE NORTH 26°15'01" EAST, A DISTANCE OF 26.57 FEET;

THENCE NORTH 68°29'19" EAST, A DISTANCE OF 109.90 FEET;

THENCE SOUTH 60°52'07" EAST, A DISTANCE OF 4.56 FEET;

THENCE NORTH 31°35'33" EAST, A DISTANCE OF 12.08 FEET;

THENCE NORTH 15°06'37" WEST, A DISTANCE OF 203.04 FEET;

EXHIBIT "G" LEGAL DESCRIPTION PG&E EASEMENT

THENCE NORTH 44°26'22" EAST, A DISTANCE OF 17.52 FEET TO THE POINT OF TERMINUS.

CONTAINING 3,737 SQUARE FEET, MORE OR LESS.

APN 155-121-27 & 29

THE BASIS OF BEARINGS FOR THE HEREIN DESCRIBED LEGAL DESCRIPTION IS TAKEN FROM DATA SHOWN ON THAT CERTAIN RECORD OF SURVEY FILED IN BOOK 17 OF SURVEYS AT PAGE 57, MARIN COUNTY RECORDS.

SEE PLAT ATTACHED HERETO AS EXHIBIT "H" AND MADE A PART HEREOF. PREPARED UNDER MY SUPERVISION

MICHAEL E. JOHNSON, L.S. 7673

5/22/20 DATE

PREPARED BY: AL CHECKED BY:




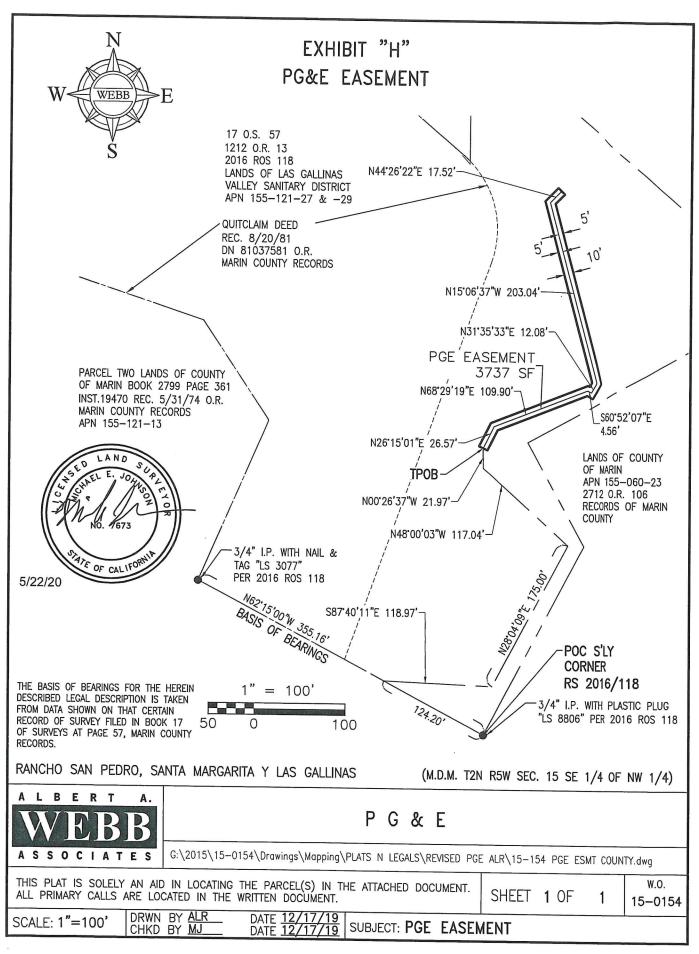


EXHIBIT "I"

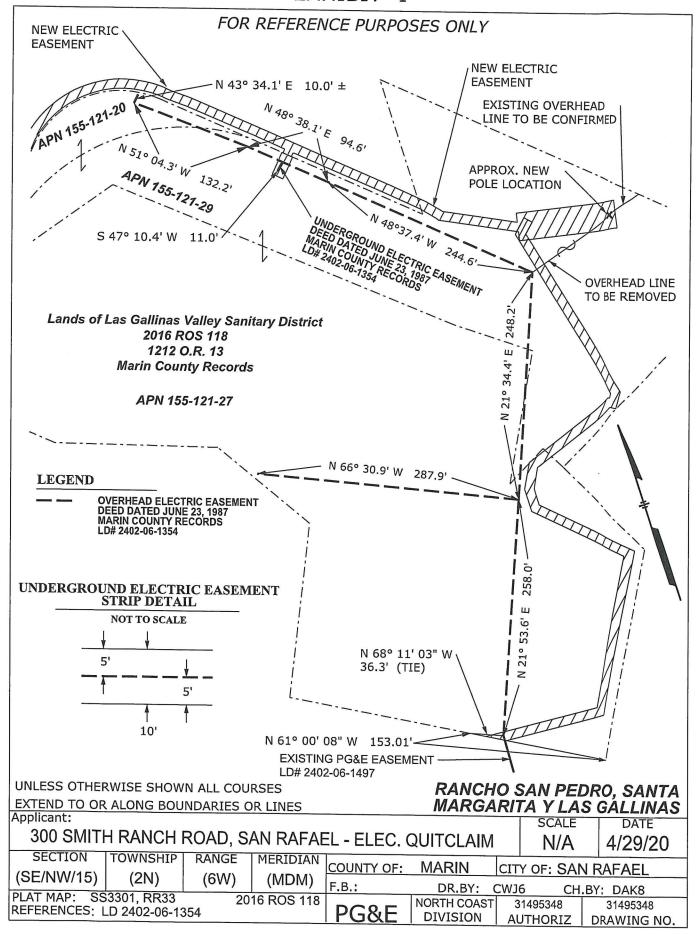

Pacific Gas and Electric Company



EXHIBIT ".J"

GRANT OF EASEMENT DISCLOSURE STATEMENT

This Disclosure Statement will assist you in evaluating the request for granting an easement to Pacific Gas and Electric Company (PG&E) to accommodate a utility service extension to PG&E's applicant. Please read this disclosure carefully before signing the Grant of Easement.

- You are under no obligation or threat of condemnation by PG&E to grant this easement.
- The granting of this easement is an accommodation to PG&E's applicant requesting the extension of PG&E utility facilities to the applicant's property or project. Because this easement is an accommodation for a service extension to a single customer or group of customers, PG&E is not authorized to purchase any such easement.
- By granting this easement to PG&E, the easement area may be used to serve additional customers in the area and **may be used to install additional utility facilities.** Installation of any proposed facilities outside of this easement area will require an additional easement.
- Removal and/or pruning of trees or other vegetation on your property may be necessary for the installation of PG&E facilities. You have the option of having PG&E's contractors perform this work on your property, if available, or granting permission to PG&E's applicant or the applicant's contractor to perform this work. Additionally, in order to comply with California fire laws and safety orders, PG&E or its contractors will periodically perform vegetation maintenance activities on your property as provided for in this grant of easement in order to maintain proper clearances from energized electric lines or other facilities.
- The description of the easement location where PG&E utility facilities are to be installed across your property must be satisfactory to you.
- The California Public Utilities Commission has authorized PG&E's applicant to perform the installation of certain utility facilities for utility service. In addition to granting this easement to PG&E, your consent may be requested by the applicant, or applicant's contractor, to work on your property. Upon completion of the applicant's installation, the utility facilities will be inspected by PG&E. When the facility installation is determined to be acceptable the facilities will be conveyed to PG&E by its applicant.

By signing the Grant of Easement, you are acknowledging that you have read this disclosure and understand that you are voluntarily granting the easement to PG&E. Please return the signed and notarized Grant of Easement with this Disclosure Statement attached to PG&E. The duplicate copy of the Grant of Easement and this Disclosure Statement is for your records.

Utility Distribution Easement (02/2020)

Attach to LD: 2402-06-10105 Area, Region or Location: 7 Land Service Office: Santa Rosa

Line of Business: Electric Distribution (43)

Business Doc Type: Easements

MTRSQ: (24.02.06.15.42), San Pedro Santa Margarita Y Las Gallinas

FERC License Number: N/A PG&E Drawing Number: N/A Plat No.: RR33, SS3301

LD of Affected Documents: 2402-06-1354

LD of Cross Referenced Documents: 2402-06-1497

Type of interest: Electric Pole Line Easements (3), Electric Underground Easements (4)

SBE Parcel: N/A

% Being Quitclaimed: N/A Order or PM: 35110428

JCN: N/A County: Marin

Utility Notice Number: N/A

851 Approval Application No: N/A ;Decision: N/A

Prepared By: CWJ6 Checked By: DAK8 DK

Approved By: Revised by: